

**Appendix A**  
**Site Photographs**

**Photo Log**  
**Alternative 2 Site (Proposed Site)**



Photo 1 – View of utility junction box near the intersection of Desire Parkway and Higgins Boulevard



Photo 2 – View of the northern portion of the proposed site and Higgins Boulevard, looking west



Photo 3 – View of the northern portion of the proposed site and Higgins Boulevard, looking east



Photo 4 – View of the northern portion of the proposed site and Higgins Boulevard, looking west





Photo 5 – View of the on-site sewer manhole



Photo 6 – View of the on-site sewer manhole and fire hydrant (right of the tree), looking northwest





Photo 7 – View looking south from the proposed project site at residences along Pleasure Street



Photo 8 – Looking south from the northeastern corner of the proposed site at Desire Parkway



Photo 9 – Looking south at the western boundary of the proposed project site and Piety Street



Photo 10 – Looking southeast from the northwest corner of the proposed site





Photo 11 – Looking southwest at the western boundary of the proposed project site and Piety Street



Photo 12 – Looking east at residential structures along Desire Parkway





Photo 13 – Looking north at the western boundary of the proposed project site and Piety Street



Photo 14 – Looking east at residential structures along Desire Parkway



Photo 15 – View of area of gravel on the proposed project site



Photo 16 – Looking north from the proposed project site at commercial structures along Higgins Boulevard





Photo 17 – Looking east at residential structures along Desire Parkway and areas of gravel on the proposed project site



Photo 18 – View of area of gravel on the proposed project site, looking west



**Photo Log**  
**Alternative 3 Site**



Photo 19 – View of the northern, maintained, portion of the Alternative 3 property, looking east from Louisa Street



Photo 20 – View of debris on the south side of the Alternative 3 site, looking east



Photo 21 – View of overgrown vegetation on the south side of the Alternative 3 site



Photo 22 – View of paved areas on the south side of the Alternative 3 site, looking east





Photo 23 – View of paved areas and overgrown vegetation on the south side of the Alternative 3 site, looking east



Photo 24 – View of concrete structure on the south side of the Alternative 3 site





Photo 25 – View of paved areas and overgrown vegetation on the south side of the Alternative 3 site, looking southeast



Photo 26 – View of debris on the western portion of the south side of the site, looking west toward Louisa Street





Photo 27 – View of concrete structure on the south side of the Alternative 3 site



Photo 28 – View of concrete structure on the south side of the Alternative 3 site





Photo 29 – View of one of several similar structures on the south side of the Alternative 3 site



Photo 30 – View of one of several similar structures on the south side of the Alternative 3 site





Photo 31 – View of Piety Street, east of the Alternative 3 site, looking north



Photo 32 – View of Piety Street at the intersection with Florida Avenue, southeast of the Alternative 3 site, looking northeast





Photo 33 – View of of the overgrown vegetation on the south side of the Alternative 3 site



Photo 34 – View of of the debris and paved areas on the south side of the Alternative 3 site





Photo 35 – View of of the overgrown vegetation and paved areas on the south side of the Alternative 3 site



Photo 36 – View of of the overgrown vegetation, debris, and structures on the south side of the Alternative 3 site

## **Appendix B**

### **Construction Plans**



# FLORIDA DESIRE MULTI-SERVICE CENTER

HIGGINS BOULEVARD, NEW ORLEANS LA 70126



**OWNER:**  
THE CITY OF NEW ORLEANS

Architect:  
**Mathes Brierre**  
ARCHITECTS  
201 St. Charles Ave., Suite 4100  
New Orleans, LA 70170-4100  
Voice (504) 586 9303 Fax (504) 582 1305  
www.mathesbrierre.com

Structural and Civil Engineer:  
**JULIEN ENGINEERING &  
CONSULTING, INC.**  
2916 General DeGaulle Drive  
Suite 200  
New Orleans, LA 70114  
(504) 366-3454

Mechanical Electrical Plumbing Engineer:  
**INFINITY ENGINEERING  
CONSULTANTS, LLC**  
4001 Division St.  
Metairie, LA 70002  
(504) 304-0548  
www.infinityec.com

**DESIGN DEVELOPMENT**  
DECEMBER 15, 2017 | MBA PROJECT NO. 11725

NOTES & SUBMITTAL REQUIREMENTS

No.	Description	Date

REV. 1.01

**Mathes Brierre**  
ARCHITECTS

201 St. Charles Avenue, Suite 4100  
New Orleans, Louisiana 70170-4100  
Voice: 504.586.9303 Fax: 504.582.1305  
mathesbrierre@mathesbrierre.com

PROJECT TITLE

FLORIDA DESIRE  
MULTI-SERVICE CENTER

DESIGN DEVELOPMENT

DESIGNED BY	DESIGNER	CHECKED BY	CHECKER
MBB/MBB	MBB	MBB	MBB
DATE	12/15/2017	DATE	12/15/2017

PROJECT NO.

COVER SHEET  
**77250 G000**

[illegible]

The diagrams illustrate clearance requirements for doors. On the left, 'CLEARANCES FOR DOORS IN SERIES' shows two door swing paths with a minimum clearance of 21" (533mm) between them. On the right, 'SWING DOOR CLEARANCES' shows a door swing path with a minimum clearance of 21" (533mm) from a wall or obstruction.

SECTION 413

SECTION 413

GLASS

DOOR

FRAME

SECTION 413

SECTION 413

NOTE: ALL DOORS IN ABOVE MUST COMPLY WITH THE DIMENSIONS NOTED FOR FRONT APPROACHES

MINIMUM CLEARANCES AT DOORS - OUTSWINGING DOORS

PUSH SIDE, RIGHT APPROACH

PUSH SIDE, IN-USE SIDE APPROACH

PULL SIDE, LATCH SIDE APPROACH

MINIMUM CLEARANCES AT DOORS - INSWINGING DOORS

DATE: 2019/04/24 16:15

No.	Description	Date

**Mathes Brierre**  
ARCHITECTS

201 St. Charles Avenue, Forty-Fifth Floor  
New Orleans, Louisiana 70119-4100  
Voice: 504.588.9312 Fax: 504.582.6306  
archibuteau@atl-estudios.com

595 800 000 000

FLORIDA DESIRE  
MULTI-SERVICE CENTER

## DESIGN DEVELOPMENT

DA Form 101-2 (Rev. 10-1-95)		DA Form 101-2 (Rev. 10-1-95)	
Designer		Checked	
Author		Date	
Title		12/15/2017	
ADA D AGRAMS			
Printed on		Printed on	

77250	G001
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RENDERING AT SOUTH FACADE  
12' x 10'



RENDERING LOOKING SOUTH  
12' x 10'

ARCHITECTURAL RENDERINGS

No.	Description	Date

APP. F. 201

**Mathes Brierre**  
ARCHITECTS

273 S. Central Ave., Suite 200  
Tampa, FL 33602  
Phone: 813.288.1111 Fax: 813.288.1112  
mathesbrierre.com

PROJECT NAME

FLORIDA DESIRE  
MULTI-SERVICE CENTER

DESIGN DEVELOPMENT

DESIGNED BY	DESIGNED BY	DESIGNED BY
DESIGNED BY	DESIGNED BY	DESIGNED BY
DESIGNED BY	DESIGNED BY	DESIGNED BY


REVISIONS

77250 G003





11725	L101
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15' TYPICAL (SEE GENERAL NOTES)

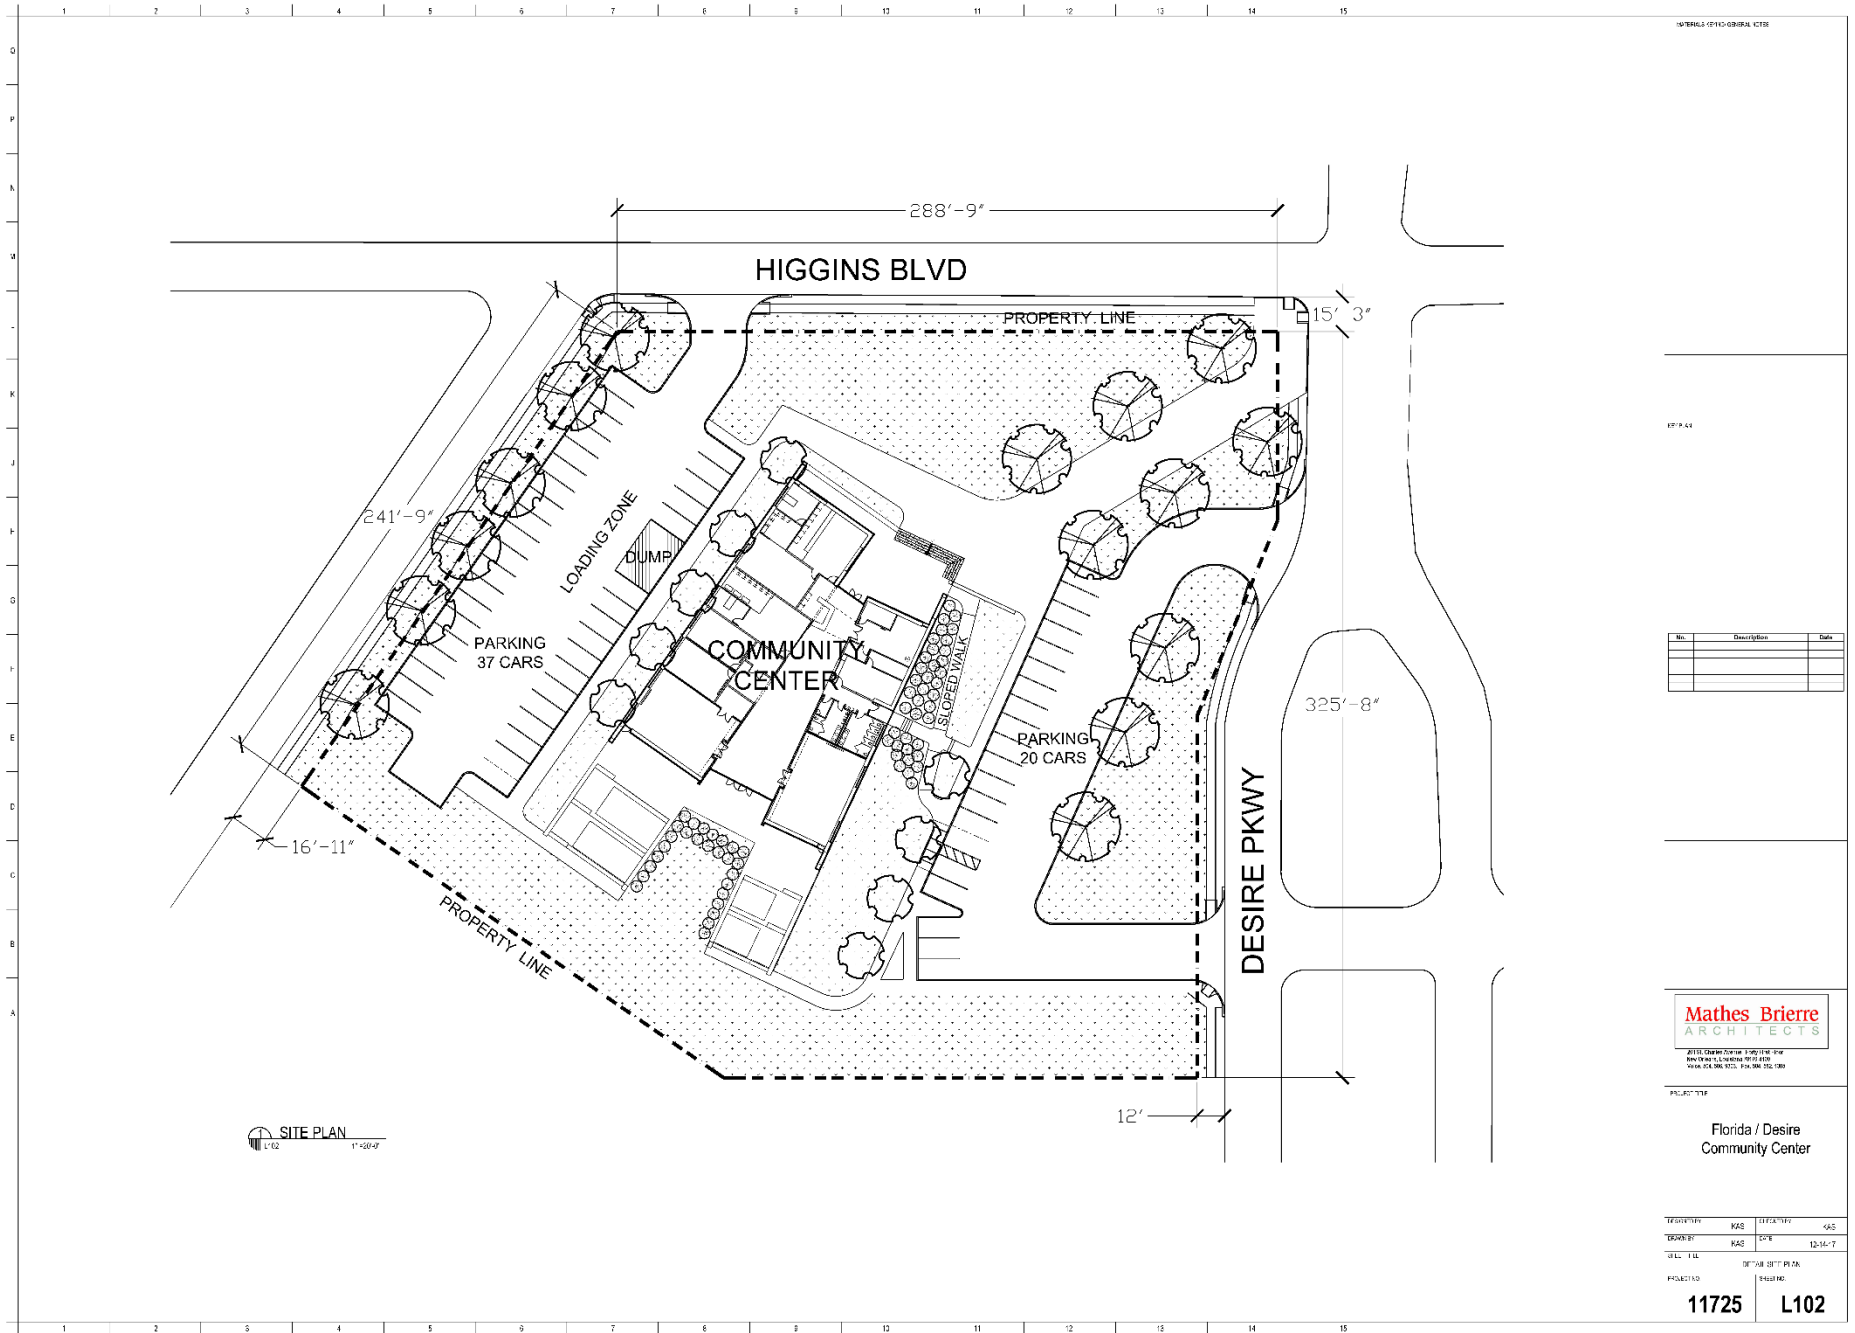15' TYPICAL

No.	Description	Date

**Mathes Brierre**  
ARCHITECTS

2015 Charlotte Street, Suite 100, Fort Lauderdale, FL 33304  
Phone: 954.586.1234 Fax: 954.586.1235  
www.mathesbrierre.com

PROJECT: 11725

Florida / Desire  
Community Center

DESIGNER: MBS DATE: 12/15/17

DRAWN BY: MBS DATE: 12/15/17

CHECKED BY: MBS DATE: 12/15/17

PROJECT NO: 11725

11725 L102



77250 C001

81

## TRAFFIC CONTROL

1. PRIOR TO THE BEGINNING OF THE CONSTRUCTION, THE CONTRACTOR SHALL OBTAIN AND SUBMIT TO THE ENGINEER AND TO THE CITY OF NEW ORLEANS TRAFFIC CHANGES FOR APPROVAL:

A. ALL EXISTING TRAFFIC CONTROL DEVICES (SIGNALS, SIGNS, BARRIERS, PAINTAGE MARKINGS, ETC.) LOCATED WITHIN OR ADJACENT TO THE PROJECT AREA.

B. ALL PLANS FOR THE PROPOSED ROAD TO BE CONSTRUCTED MARKINGS AND EQUIPMENT ARE TO BE TRANSPORTED TO AND FROM THE CONSTRUCTION SITE.

C. A DETAILED PLAN SHOWING PROPOSED ROUTES FOR LOCAL TRAFFIC AND "THROUGHT TRAFFIC" ON WHICH TRAFFIC WILL BE DIVERTED TO OTHER ROADS OR TO OTHER STREETS OR HIGHWAYS. ALL TRAFFIC DIVERSIONS ARE TO BE DONE WITHIN THE PROJECT AREA. APPROXIMATELY A WEEKS SHALL BE IN COMPLIANCE WITH THE CITY OF NEW ORLEANS TRAFFIC CHANGES FOR APPROVAL.

2. TRAFFIC PLANS SHALL INCLUDE WALK AND TELEPHONE NUMBER OF RESPONSIBLE PERSONNEL, IN CHARGE OF PROJECT.

3. THE CONTRACTOR SHALL SUBMIT APPROVAL OF THE CITY OF NEW ORLEANS TRAFFIC ENGINEER FOR ANY TRAFFIC DIVERSION PLANS. INCLUDING REDUCTION OR REMOVAL OF ANY OF THE CONTROL DEVICES BEFORE OR DURING THE COURSE OF THE PROJECT.

4. ALL MATERIALS AND EQUIPMENT TO BE USED IN COMPLIANCE WITH THE CONSTRUCTION OF WORK SHALL BE TRAFFIC CONTROL PLANS SHALL BE CONSIDERED OR APPROVED BY THE CONTRACTOR. THE REMOVED DEVICES OR

## SIDEWALKS

[illegible]

2. ALL WHEEL STOPS  
THIS PLAN.

3. HANDPAVING SPACING SHALL BE DETERMINED BY 6" BULKY STEERING AND EITHER A BLUE STRIPE, OR A WHITE STRIPE OR A WHITE PINK, OR A WHITE PINK, OR A BLUE BACKGROUND. HANDPAVING STRIPES/STRIKES SHALL BE PLACED IN ACCORDANCE WITH THE FOLLOWING:

4. ALL WALK, STOP, AND CONCRETE CURBS SHALL BE CONSTRUCTED IN ACCORDANCE WITH THE DETAIL SHOWN ON THIS PLAN.

5. HANDPAVING SPACING SHALL BE Laid OUT IN ACCORDANCE WITH THE TYPICAL DETAIL AS SHOWN ON THIS PLAN, UNLESS OTHERWISE INDICATED ON THIS PLAN.

6. ALL PAVING LAYING SHALL BE CONSTRUCTED OF P.C. FINISHED, AND SHALL ATTAIN A COMPRESSIVE STRENGTH OF 4,000psi AT 28 DAYS. REINFORCING SHALL CONSIST OF #4x2 @ 12" ON CENTER PLACED AT MID-HEIGHT.

**DRIVEWAYS:**

1. ALL DRIVEWAYS BETWEEN STREET AND PROPERTY AND SHALL BE CONSTRUCTED OF P.C. FINISHED AND SHALL ATTAIN A COMPRESSIVE STRENGTH OF 4,000psi AT 28 DAYS AND SHALL BE A MINIMUM THICKNESS OF 8" AND SHALL BE PLACED IN ACCORDANCE WITH THE FOLLOWING:

2. ALL DRIVEWAYS BETWEEN STREET AND PROPERTY ON CORNERING WITH AN EXISTING DRIVEWAY SHALL BE CONSTRUCTED IN ACCORDANCE WITH DETAIL AS SHOWN ON THIS PLAN AND SHALL RECEIVE A BROOK FINISH.

## SITE DEMOLITION

4. CONTRACTOR WILL CONTACT THE PARISH DEPARTMENT OF PUBLIC WORKS, 2 DAYS PRIOR TO THE FORMING OF DRIVEWAYS CONNECTING TO THE ROADWAY.

**SITE DEMOLITION / PREPARATION:**

1. REMOVE ALL EXISTING TREES, TREE CLUSTERS, AND OBSTRUCTIONS ONLY WITHIN THE WORK AREA AS NECESSARY.

## SITE DEMOLITION / PREPARATION

1. REMOVE ALL EXISTING DITCHES, TREE CLUSTERS, AND OBSTRUCTIONS ONLY WITHIN THE WORK AREA AS NECESSARY TO INSTALL NEW WORK. SEE SITE SURVEY FOR LOCATION OF TREES AND OBSTRUCTIONS.
2. REMOVE EXISTING GRASS, PAVING AND OTHER VEGETATION WITHIN THE WORK AREA.
3. REMOVE ALL ROADS, TRAILS, DEMOLISHED MATERIALS AND DEBRIS FROM SITE AS DISPOSE OF LEGALLY.
4. USE OF EXPLOSIVES IS PROHIBITED.
5. REMOVE ALL EXISTING ROLL-OVER CURBS ONLY WITHIN THE WORK AREA AS NECESSARY TO INSTALL NEW WORK (DECELERATION LANS, WALKWAYS, ETC.).

8. THE CONTRACTOR SHALL MAINTAIN 50% OF ROADWAY TEMPORARY ROADWAY ACCEPTABLE TO THE CITY.

8. ANY WORK IN OR ADJACENT TO THE ROADWAY CAUSING AN INTERFERENCE TO VEHICULAR TRAFFIC REQUIRES PRE-Notification TO THE CITY OF NEW ORLEANS TRAFFIC ENGINEERING DIVISION AND CONFORMITY TO THE REQUIREMENTS OF THE UNIFORM MANUAL ON TRAFFIC CONTROL DEVICES OF THE STATE OF LOUISIANA. THE CONTRACTOR MUST FINISH ALL NECESSARY TRAFFIC SIGNS AND/OR BARRICADES, AND MAINTAIN THEM DURING CONSTRUCTION ACTIVITY.

10. CONTRACTOR SHALL APPLY FOR, COORDINATE, AND PAY FOR ALL TRAFFIC PERMITS.

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SITE AS-BUILT DOCUMENTATION	
1.	SPON COMPLETION OF ALL SITE WORK, CONTRACTOR SHALL PROVIDE AN AS-BUILT TOPOGRAPHIC SLURRY OF THE SITE.
2.	THIS SURVEY SHALL INCLUDE, BUT NOT LIMITED TO:
	<ul style="list-style-type: none"> <li>A. GRADE ELEVATIONS AT EACH GRADE ELEVATION INDICATED ON CONTRACT DRAWINGS</li> <li>B. DIRECTION AND EXPOSURE OF ALL UTILITIES</li> <li>C. INDICATE THE PRESENCE OF ALL UNDERGROUND SEWER, WATER, AND GASEY PIPES AS WELL AS INVERTS AND TOPS OF ALL ASSOCIATED MANHOLES AND MANHOLE COVERS</li> <li>D. FINAL LOCATIONS OF MANHOLES, INLETS, VALVES, HYDRANTS, METERS, CLEANOUTS, ETC.</li> </ul>

F. FINAL LOCATIONS OF ALL SITE ELEMENTS, PER

3. THE AS-BUILT SURVEY SHALL BE PROVIDED IN (2) HAND COPIES OF FULL SIZED PUNCH SHEETS, PDF FORMAT, STAMPED BY A REGISTERED PROFESSIONAL SURVEYOR, AND PROVIDED IN AUTOCAD 2000 FORMAT. DO NOT PROVIDE IN AUTOCAD CIVIL 3D.

4. IN SUCH CASE IT IS DETERMINED THAT THE AS-BUILT SURVEY DOES NOT ACCURATELY REFLECT ACTUAL, FINAL SITE CONDITIONS, CONTRACTOR SHALL BEAR ALL COSTS RELATED TO SUBSEQUENT FIELD INVESTIGATIONS AND FOLLOW-UP REVISIONS TO AS-BUILT DOCUMENTATION IN-WHOLE INCURRED BY CONTRACTOR OR ANY OTHER PARTY.

**Abstract**

77250	C100
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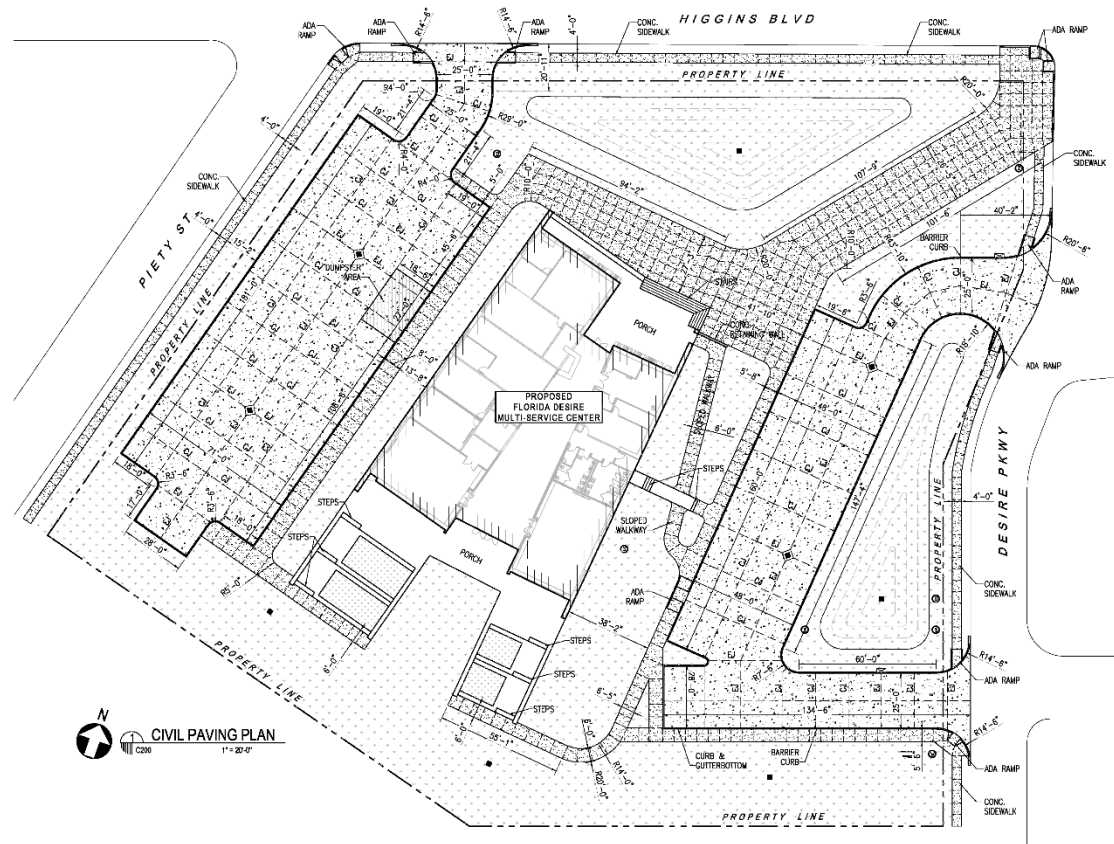
JE No. 17035


 SCALES IN THIS DRAWING ARE AS SHOWN  
 WHEN THIS BAR MEASURES 1' LONG

## PRELIMINARY PLANS

NOT FOR CONSTRUCTION

MATERIALS KEYING GENERAL NOTE



  **CIVIL PAVING PLAN**  
1" = 20'-0"

### PAVING LEGEND

- |     |     |                 |                         |
|-----|-----|-----------------|-------------------------|
| --- | --- | $\frac{X}{100}$ | PEDESTRIAN FRINGE JOINT |
| --- | U   | $\frac{X}{100}$ | EXTENSION JOINTS        |
| --- | SL  | $\frac{X}{100}$ | CONTRACT JOINTS         |

SEE CIV. SITE SHEET C-100  
LEGEND INFORMATION NOT  
SHOWN HERE

No.	Description	Date

KEY PLAN

**Mathes Brierre**  
ARCHITECTS

201 St. Charles Avenue, Forty First Floor  
New Orleans, Louisiana 70170-4108  
Voice: 504.566.2185 Fax: 504.582.1305

PROJECT TITLE
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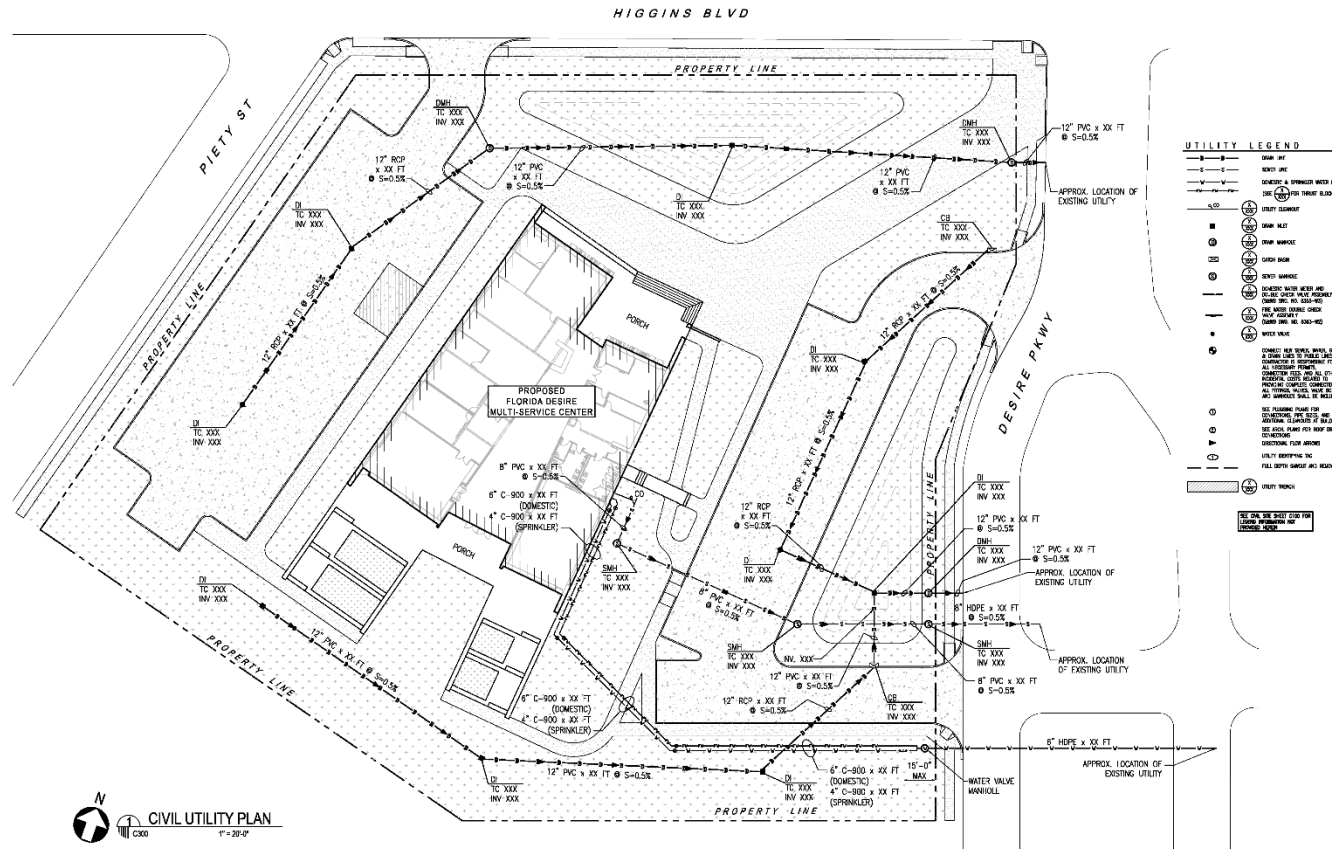
FLORIDA DESIRE  
MULTI-SERVICE CENTER

DESIGNED BY	AJM	CHECKED BY	KE
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ORIGIN BY	DATE
AIM	12/15/201

CIVIL PAVING PLAN

77250	C200
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[illegible]

COPY PLAN

**Mathes Brierre**  
ARCHITECTS

281 St. Charles Avenue, Forty-Fifth Floor  
New Orleans, Louisiana 70170-4100  
Voice: 504.588.9303, Fax: 504.582.1386

PROJECT TITLE:

FLORIDA DESIRE  
MULTI-SERVICE CENTER

DESIGNED BY	AJM	CHECKED BY	KEJ
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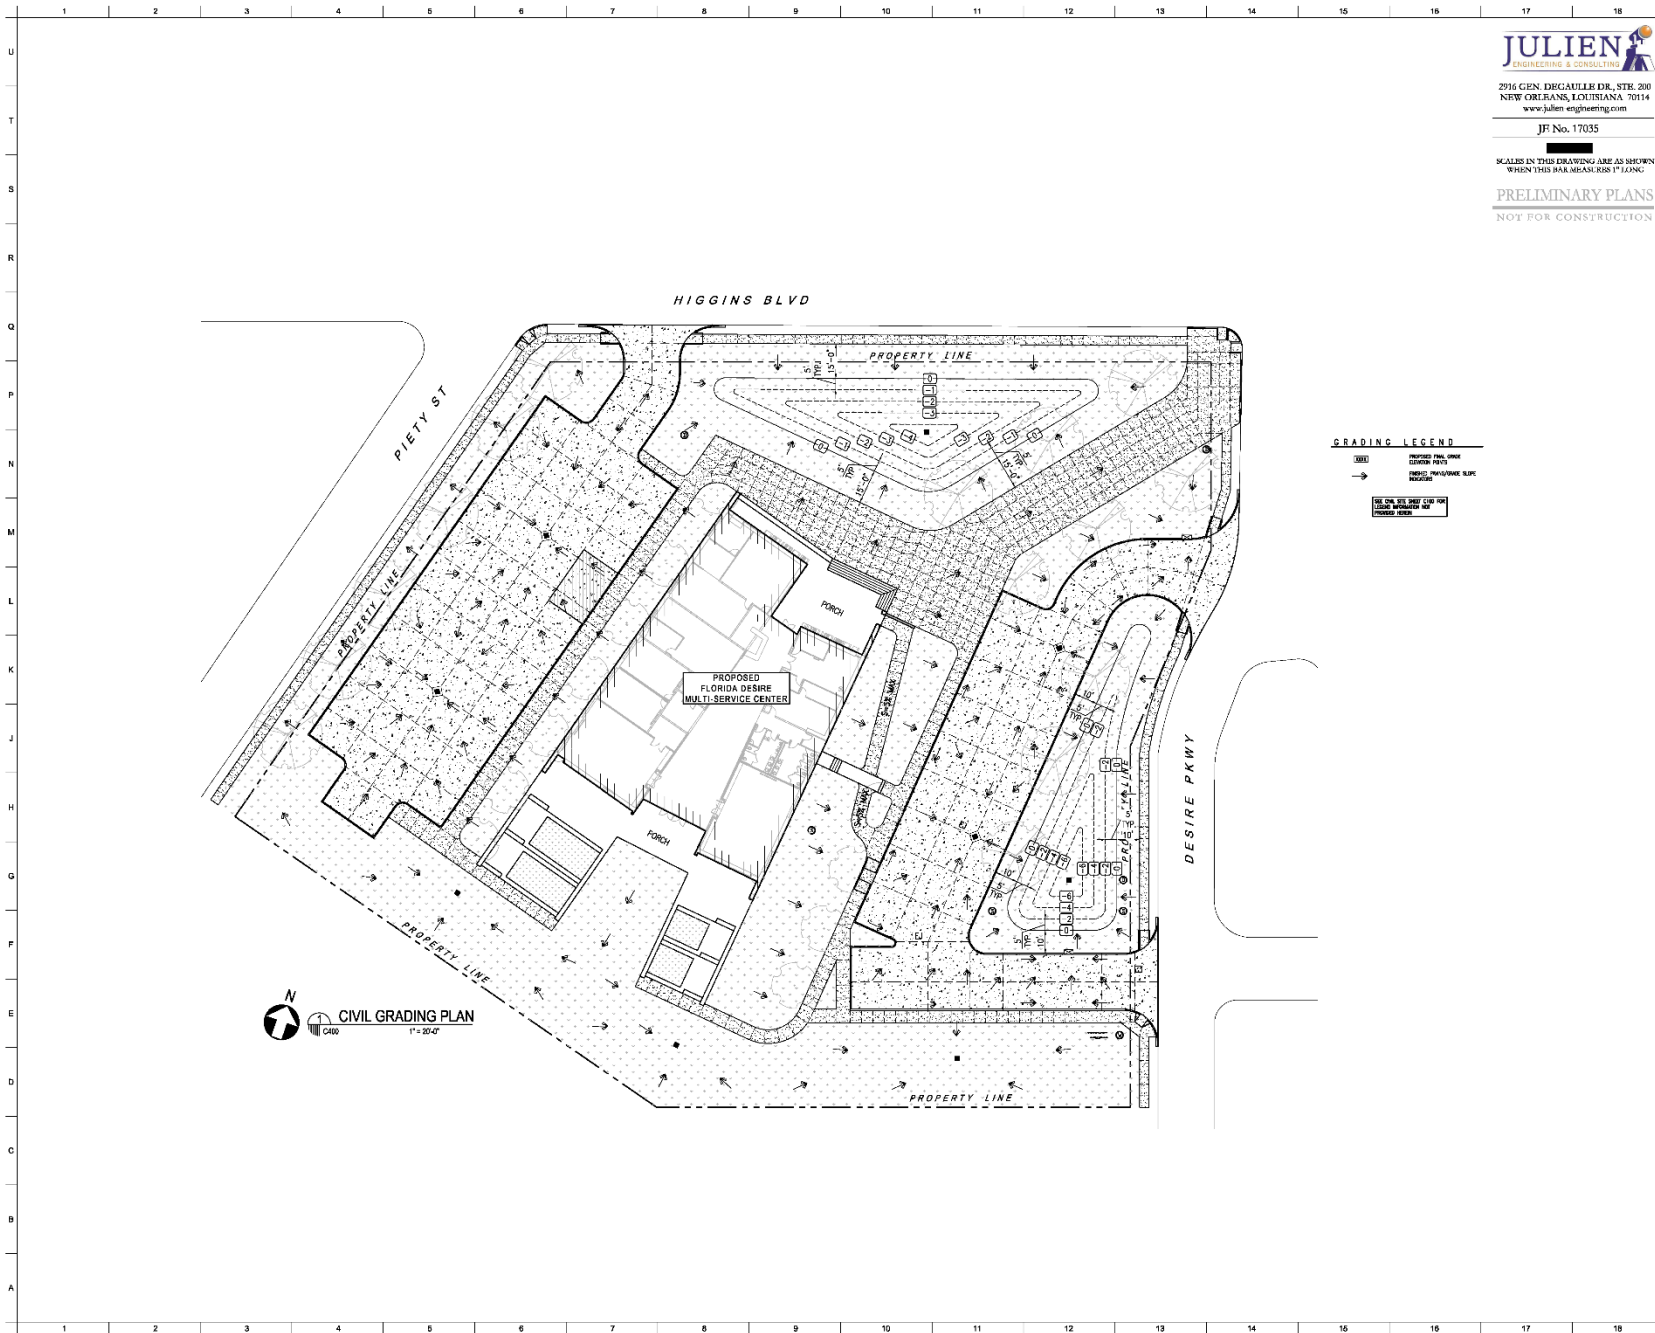
DIVISION	AJ	DATE	12/16/2017
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SHEET TITLE	CIVIL UTILITY PLAN
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PROJECT NO.	SHEET NO.
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77250	C300
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2916 GEN. DEGAULLE DR., STE. 200  
NEW ORLEANS, LOUISIANA 70114  
www.julien-engineering.com

JF No. 17035

SCALES IN THIS DRAWING ARE AS SHOWN  
WHEN THIS BAR MEASURES 1" LONG

PRELIMINARY PLANS  
NOT FOR CONSTRUCTION

WATER/KEY/NO GENERAL NOTES

GRADING LEGEND	
	PROPOSED FINAL WORK
	PROPOSED FINAL WORK
	PROPOSED FINAL WORK

No.	Description	Date

KEY PLAN

**Mathes Brierre**  
ARCHITECTS

301 St. Charles Avenue, First Floor  
New Orleans, Louisiana 70119-4101  
Phone: (504) 586-8975 Fax: (504) 586-8976

PROJECT TITLE


FLORIDA DESIRE  
MULTI-SERVICE CENTER

DESIGNED BY AJM CHECKED BY KEJ

DRAWN BY AJM DATE 12/15/2017

SHEET NAME CIVIL GRADING PLAN

PROJECT NO. 77250 SHEET NO. C400

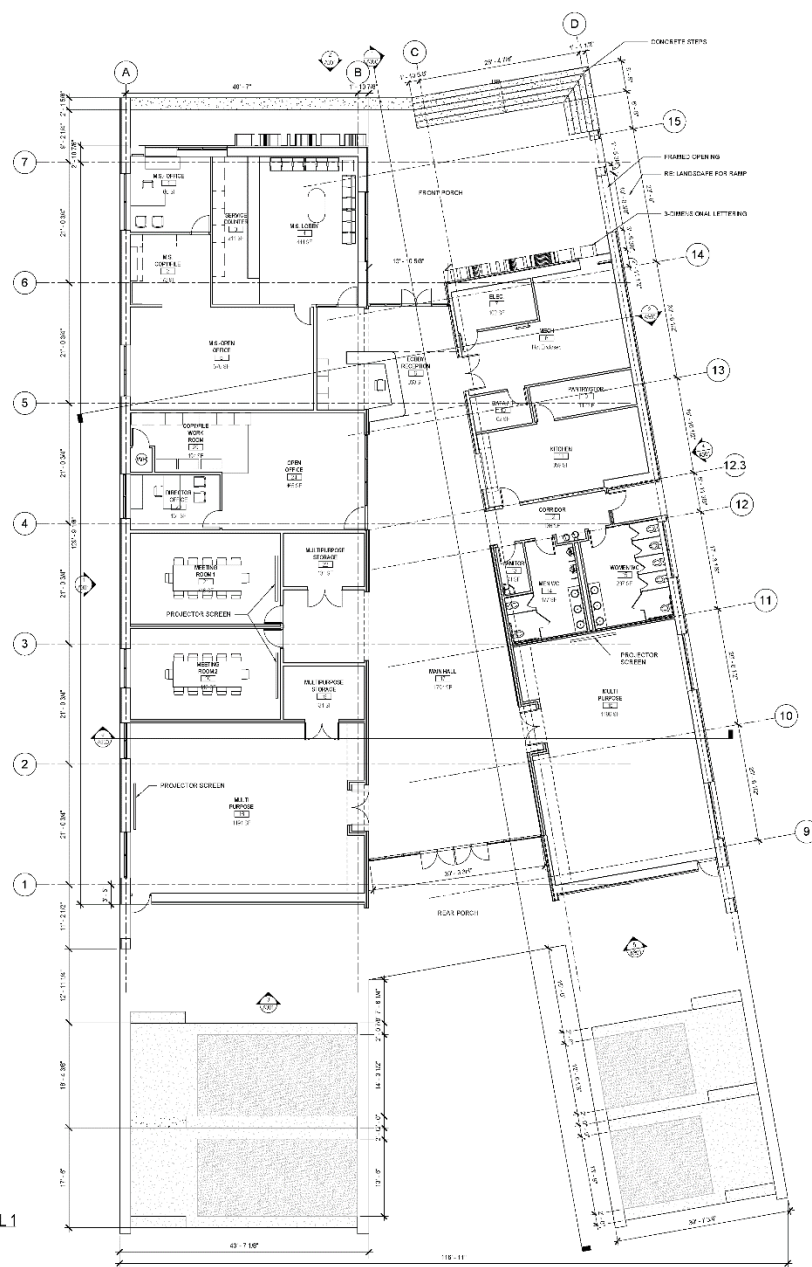


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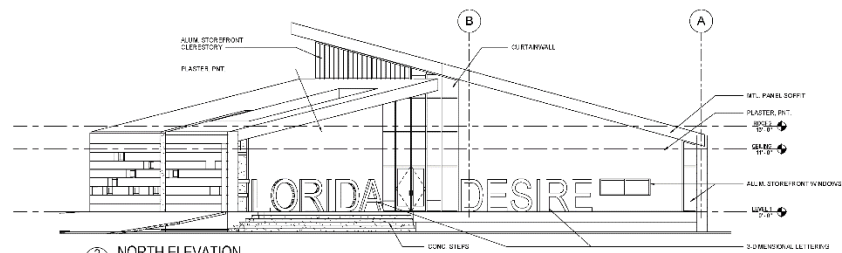










1 WEST ELEVATION  
18' x 1'-0"

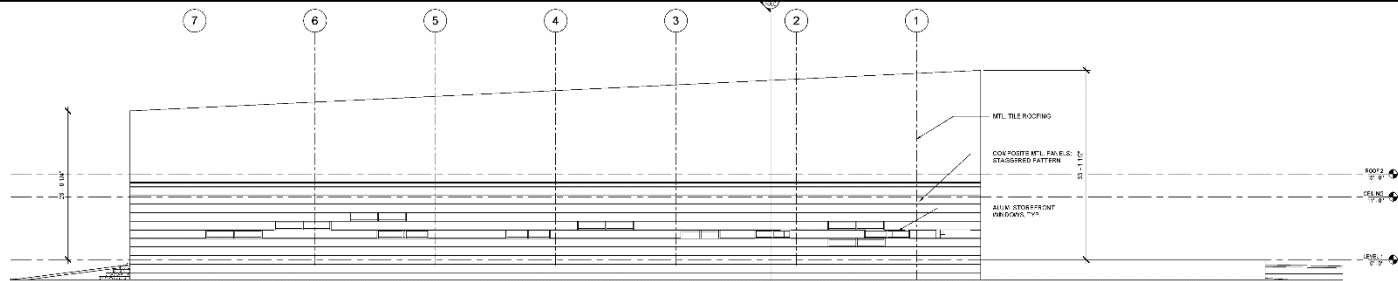


2 NORTH ELEVATION  
18' x 1'-0"

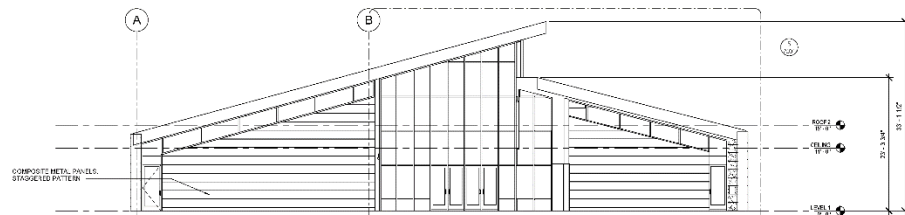

3 SOUTH ELEVATION  
18' x 1'-0"

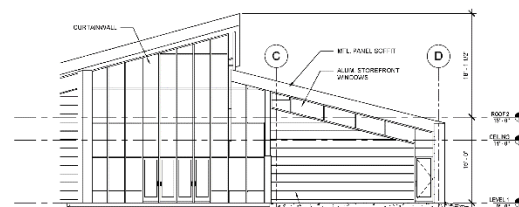

5 SOUTH PART ELEVATION  
18' x 1'-0"

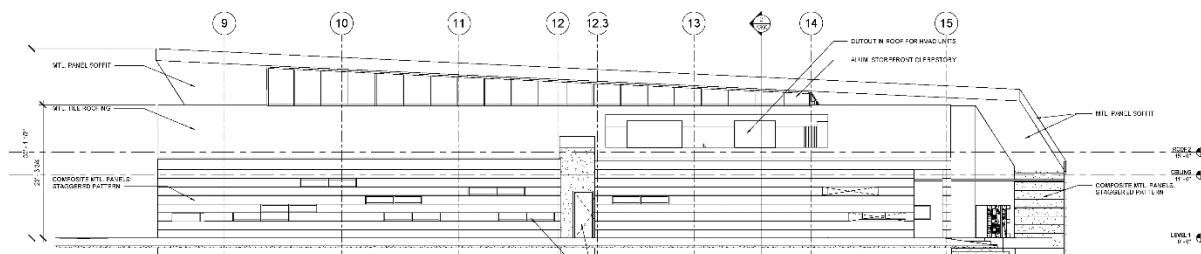

4 EAST ELEVATION  
18' x 1'-0"

NOTE: A. SEE ELEVATION 18' x 1'-0"

No. Description Date

Mathes Brierre  
ARCHITECTS

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FLORIDA DESIRE  
MULTI-SERVICE CENTER


DESIGN DEVELOPMENT

DESIGNER: MATHES BRIERRE ARCHITECTS


DATE: 12/20/2017

EXTERIOR ELEVATIONS

77250 A301

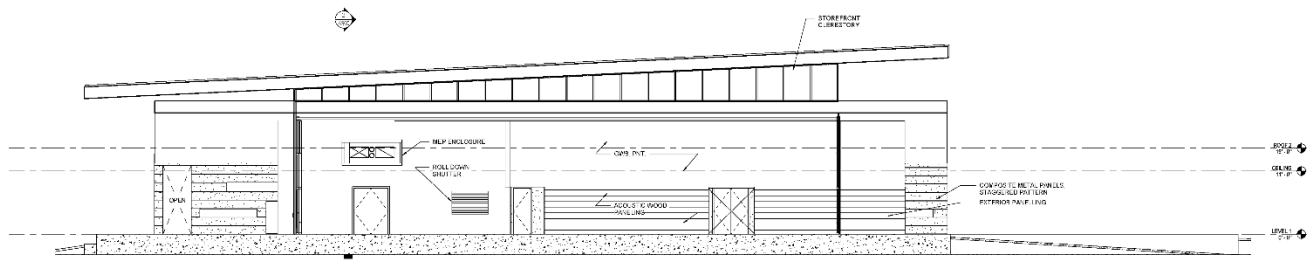

**BUILDING SECTION EAST**  
1/8" = 1'-0"

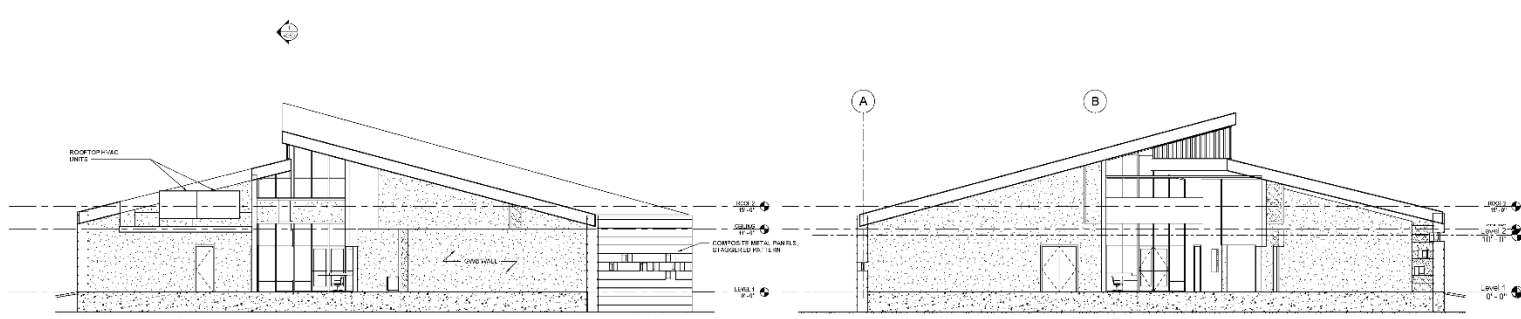

**BUILDING SECTION SOUTH**  
1/8" = 1'-0"

**BUILDING SECTION NORTH**  
1/8" = 1'-0"

SECTION 2 - BUILDING SECTIONS

No.	Description	Date

REV. 1.01

**Mathes Briere**  
ARCHITECTS

2818 S. Charles Avenue, Suite 100, Fort Worth, TX 76104  
Phone: 817.551.1821 Fax: 817.551.1822  
mathesbriere@gmail.com

PROJECT FILE

**FLORIDA DESIRE  
MULTI-SERVICE CENTER**

**DESIGN DEVELOPMENT**

DESIGNED BY	DESIGNER	DATE	OWNER
MBB/2017	MBB/2017	12/15/2017	

**BUILDING SECTIONS**

PROJECT NO.	77250	A350
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1	2	3	4	5	6	7	8	9	10	11	12	13	14	15	16	17	18
U																	
T																	
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F																	
E																	
D																	
C																	
B																	
A																	
1	2	3	4	5	6	7	8	9	10	11	12	13	14	15	16	17	18

FINISH SCHEDULE 2									
NUMBER	NAME	FLOOR	BASE	NORTH WALL	SOUTH WALL	EAST WALL	WEST WALL	CEILING	COMMENTS

FINISH SCHEDULE 2									
NUMBER	NAME	FLOOR	BASE	NORTH WALL	SOUTH WALL	EAST WALL	WEST WALL	CEILING	COMMENTS

FINISH SCHEDULE 2									
NUMBER	NAME	FLOOR	BASE	NORTH WALL	SOUTH WALL	EAST WALL	WEST WALL	CEILING	COMMENTS
1	AC-1000	201	2.1					201	
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3	AC-1000	201	2.1					201	
4	AC-1000	201	2.1					201	
5	AC-1000	201	2.1					201	
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7	AC-1000	201	2.1					201	
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89	AC-1000	201	2.1					201	
90	AC-1000	201	2.1					201	
91	AC-1000	201	2.1					201	
92	AC-1000	201	2.1					201	
93	AC-1000	201	2.1					201	
94	AC-1000	201	2.1					201	
95	AC-1000	201	2.1					201	
96	AC-1000	201	2.1					201	
97	AC-1000	201	2.1					201	
98	AC-1000	201	2.1					201	
99	AC-1000	201	2.1					201	
100	AC-1000	201	2.1					201	

MATERIAL SCHEDULE					
ITEM NO.	CATEGORY	DESCRIPTION	MANUFACTURER	PRODUCT/COLOR	NOTES
101	PAINT	AC-1000		AC-1000	
102	PAINT	AC-1000		AC-1000	
103	PAINT	AC-1000		AC-1000	
104	PAINT	AC-1000		AC-1000	
105	PAINT	AC-1000		AC-1000	
106	PAINT	AC-1000		AC-1000	
107	PAINT	AC-1000		AC-1000	
108	PAINT	AC-1000		AC-1000	
109	PAINT	AC-1000		AC-1000	
110	PAINT	AC-1000		AC-1000	
111	PAINT	AC-1000		AC-1000	
112	PAINT	AC-1000		AC-1000	
113	PAINT	AC-1000		AC-1000	
114	PAINT	AC-1000		AC-1000	
115	PAINT	AC-1000		AC-1000	
116	PAINT	AC-1000		AC-1000	
117	PAINT	AC-1000		AC-1000	
118	PAINT	AC-1000		AC-1000	
119	PAINT	AC-1000		AC-1000	
120	PAINT	AC-1000		AC-1000	
121	PAINT	AC-1000		AC-1000	
122	PAINT	AC-1000		AC-1000	
123	PAINT	AC-1000		AC-1000	
124	PAINT	AC-1000		AC-1000	
125	PAINT	AC-1000		AC-1000	
126	PAINT	AC-1000		AC-1000	
127	PAINT	AC-1000		AC-1000	
128	PAINT	AC-1000		AC-1000	
129	PAINT	AC-1000		AC-1000	
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135	PAINT	AC-1000		AC-1000	
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137	PAINT	AC-1000		AC-1000	
138	PAINT	AC-1000		AC-1000	
139	PAINT	AC-1000		AC-1000	
140	PAINT	AC-1000		AC-1000	
141	PAINT	AC-1000		AC-1000	
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194	PAINT	AC-1000		AC-1000	
195	PAINT	AC-1000		AC-1000	
196	PAINT	AC-1000		AC-1000	
197	PAINT	AC-1000		AC-1000	
198	PAINT	AC-1000		AC-1000	
199	PAINT	AC-1000		AC-1000	
200	PAINT	AC-1000		AC-1000	



**FINISH LEGEND**

ROOM	ROOM NAME
101	ROOM NUMBER
101	FLOOR FINISH
101	WALL FINISH
101	BASE FINISH
101	CEILING FINISH (SEE REFLECTED CEILING PLAN AND MATERIAL LIST)

**MATERIAL LEGEND**  
1750 = 1.0\*

No.	Description	Date

**Mathes Brierre**  
ARCHITECTS

201 St. Charles Avenue, Early First Floor  
New Orleans, Louisiana 70116-0100  
Voice 504.581.9302, Fax 504.582.5506  
a.k.b.brierre@mathes-brierre.com


FLORIDA DESIRE  
MULTI-SERVICE CENTER

## DESIGN DEVELOPMENT

DESIGNED BY	DESIGNER	CHECKED BY	CHECKER
DRAWN BY	AUTHOR	DATE	12/5/2017
FLOOR FINISH PLAN			

77250	A705
-------	------



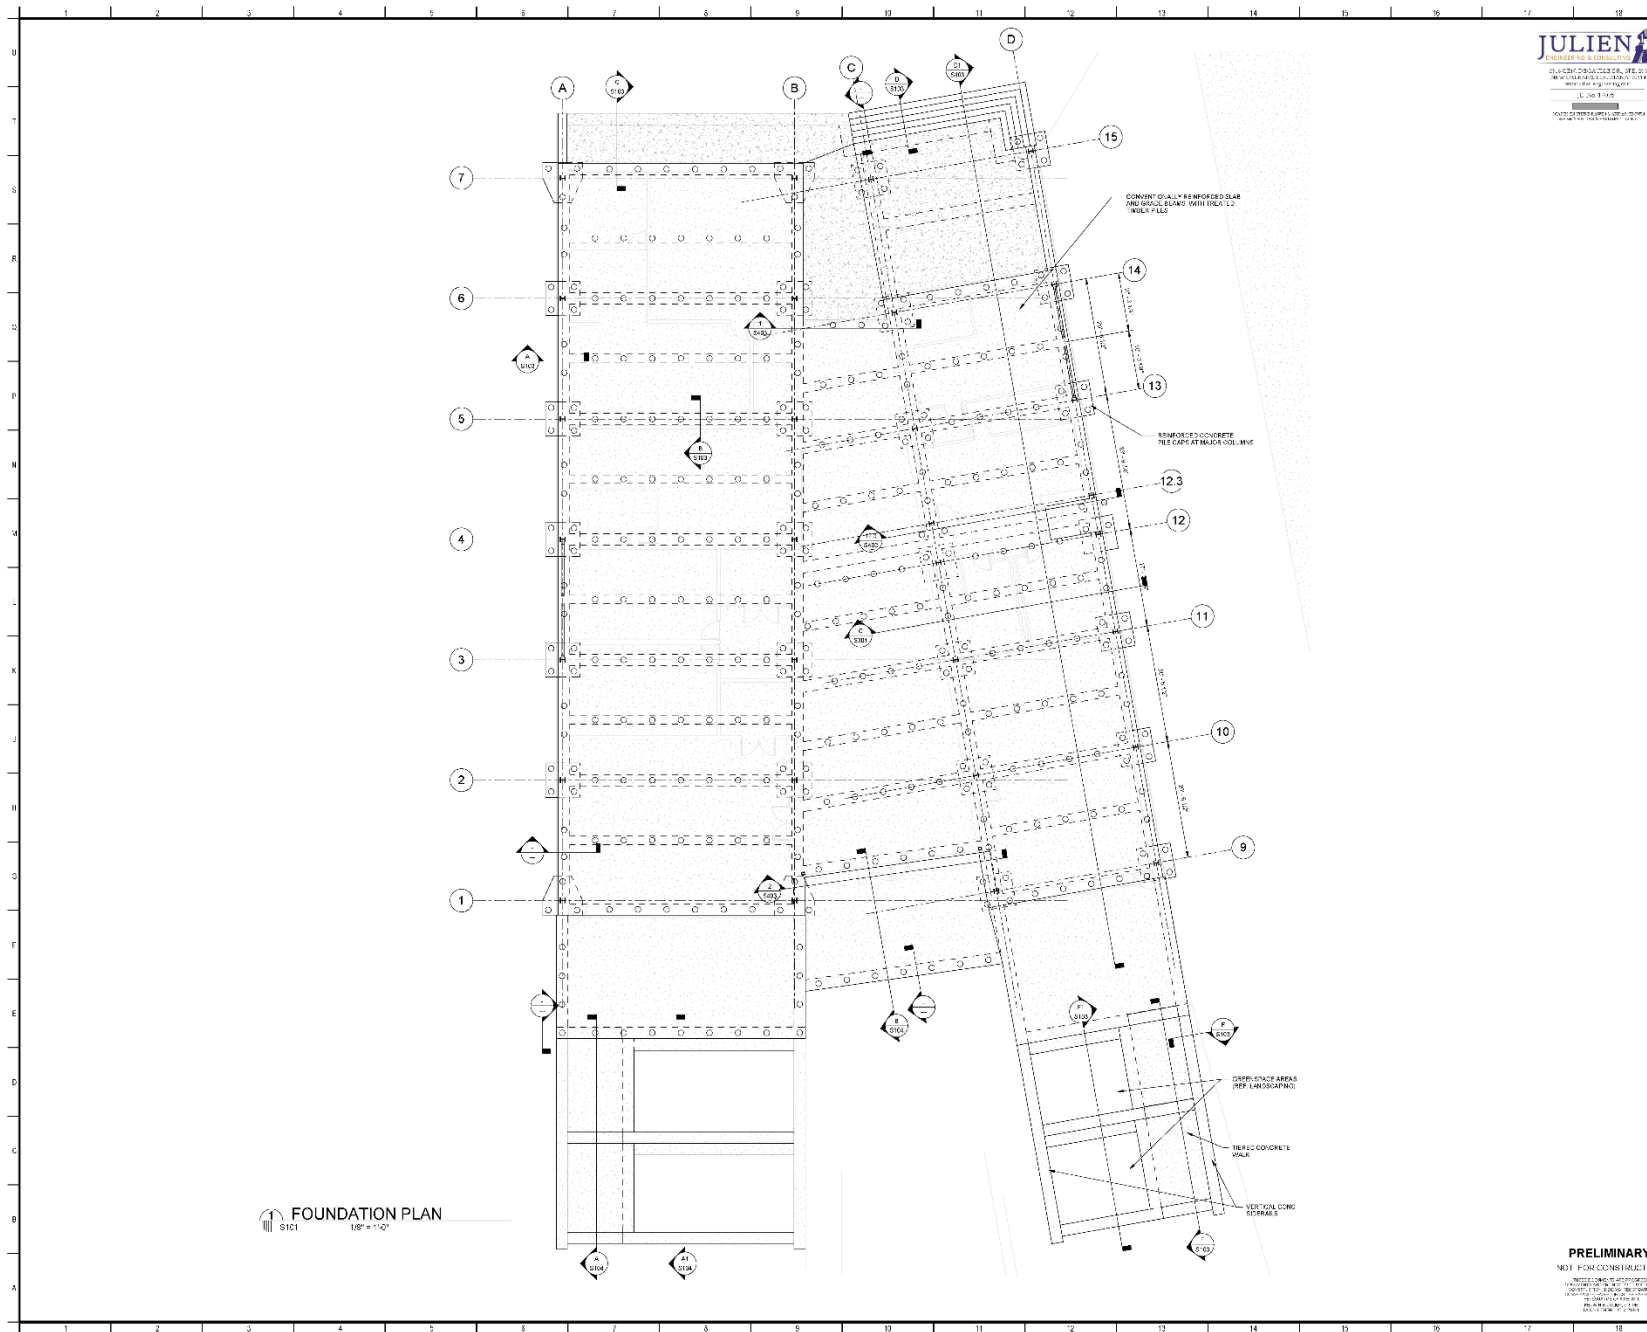

**JULIEN**  
ENGINEERING & CONSULTING  
2111 CENTRE DRIVE, SUITE 201  
ANN ARBOR, MI 48106-1074  
www.julien-engineering.com  
Tel: 734.769.1100  
Fax: 734.769.1101  
juliene@julien-engineering.com

NOTES & REFERENCES TO OTHERS

No.	Description	Date

REVISED


**Mathes Brierre**  
ARCHITECTS  
2010 Charles Avenue, Suite 100  
Ann Arbor, MI 48106-1074  
Tel: 734.769.1100  
Fax: 734.769.1101  
mb@mathesbrierre.com

FLORIDA DESIRE  
MULTI-SERVICE CENTER

**PRELIMINARY**  
NOT FOR CONSTRUCTION

DESIGNED BY	KEJ/J	CHECKED BY	KEJ/J
DATE	12/2/2017	DATE	12/2/2017

PROJECT NO. **77250** S101

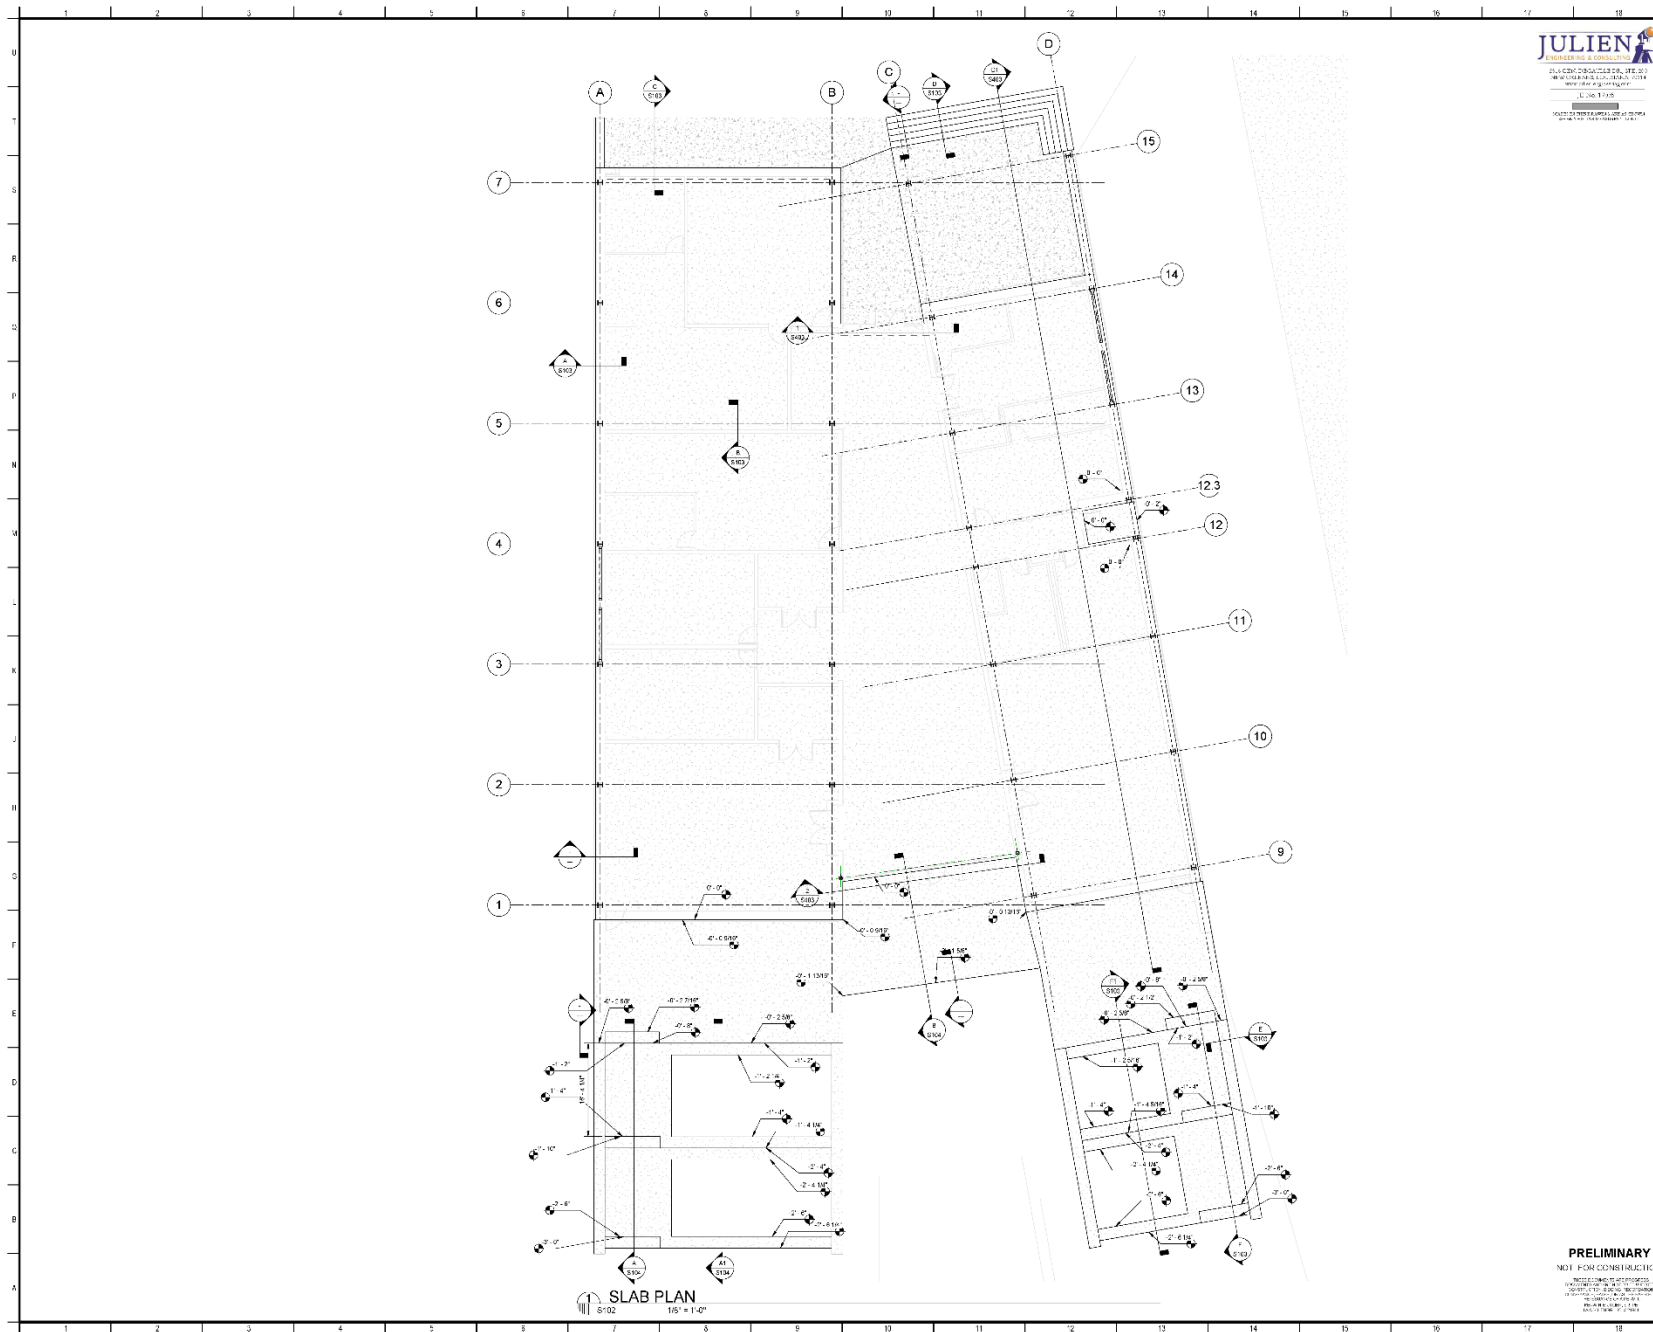

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No.	Description	Date

FOR: MATHES BRIERRE ARCHITECTS

**Mathes Brierre**  
ARCHITECTS


2010 Charles Avenue, Suite 100, Fort Lauderdale, FL 33304  
Phone: 954.581.1111 Fax: 954.581.1112  
info@mathesbrierre.com

PROJECT: FLORIDA DESIRE  
MULTI-SERVICE CENTER

DESIGNED BY:	DESIGNED BY:	DESIGNED BY:
CHECKED BY:	CHECKED BY:	CHECKED BY:
DATE:	DATE:	DATE:

DESIGNED BY:	DESIGNED BY:	DESIGNED BY:
CHECKED BY:	CHECKED BY:	CHECKED BY:
DATE:	DATE:	DATE:

77250 S102

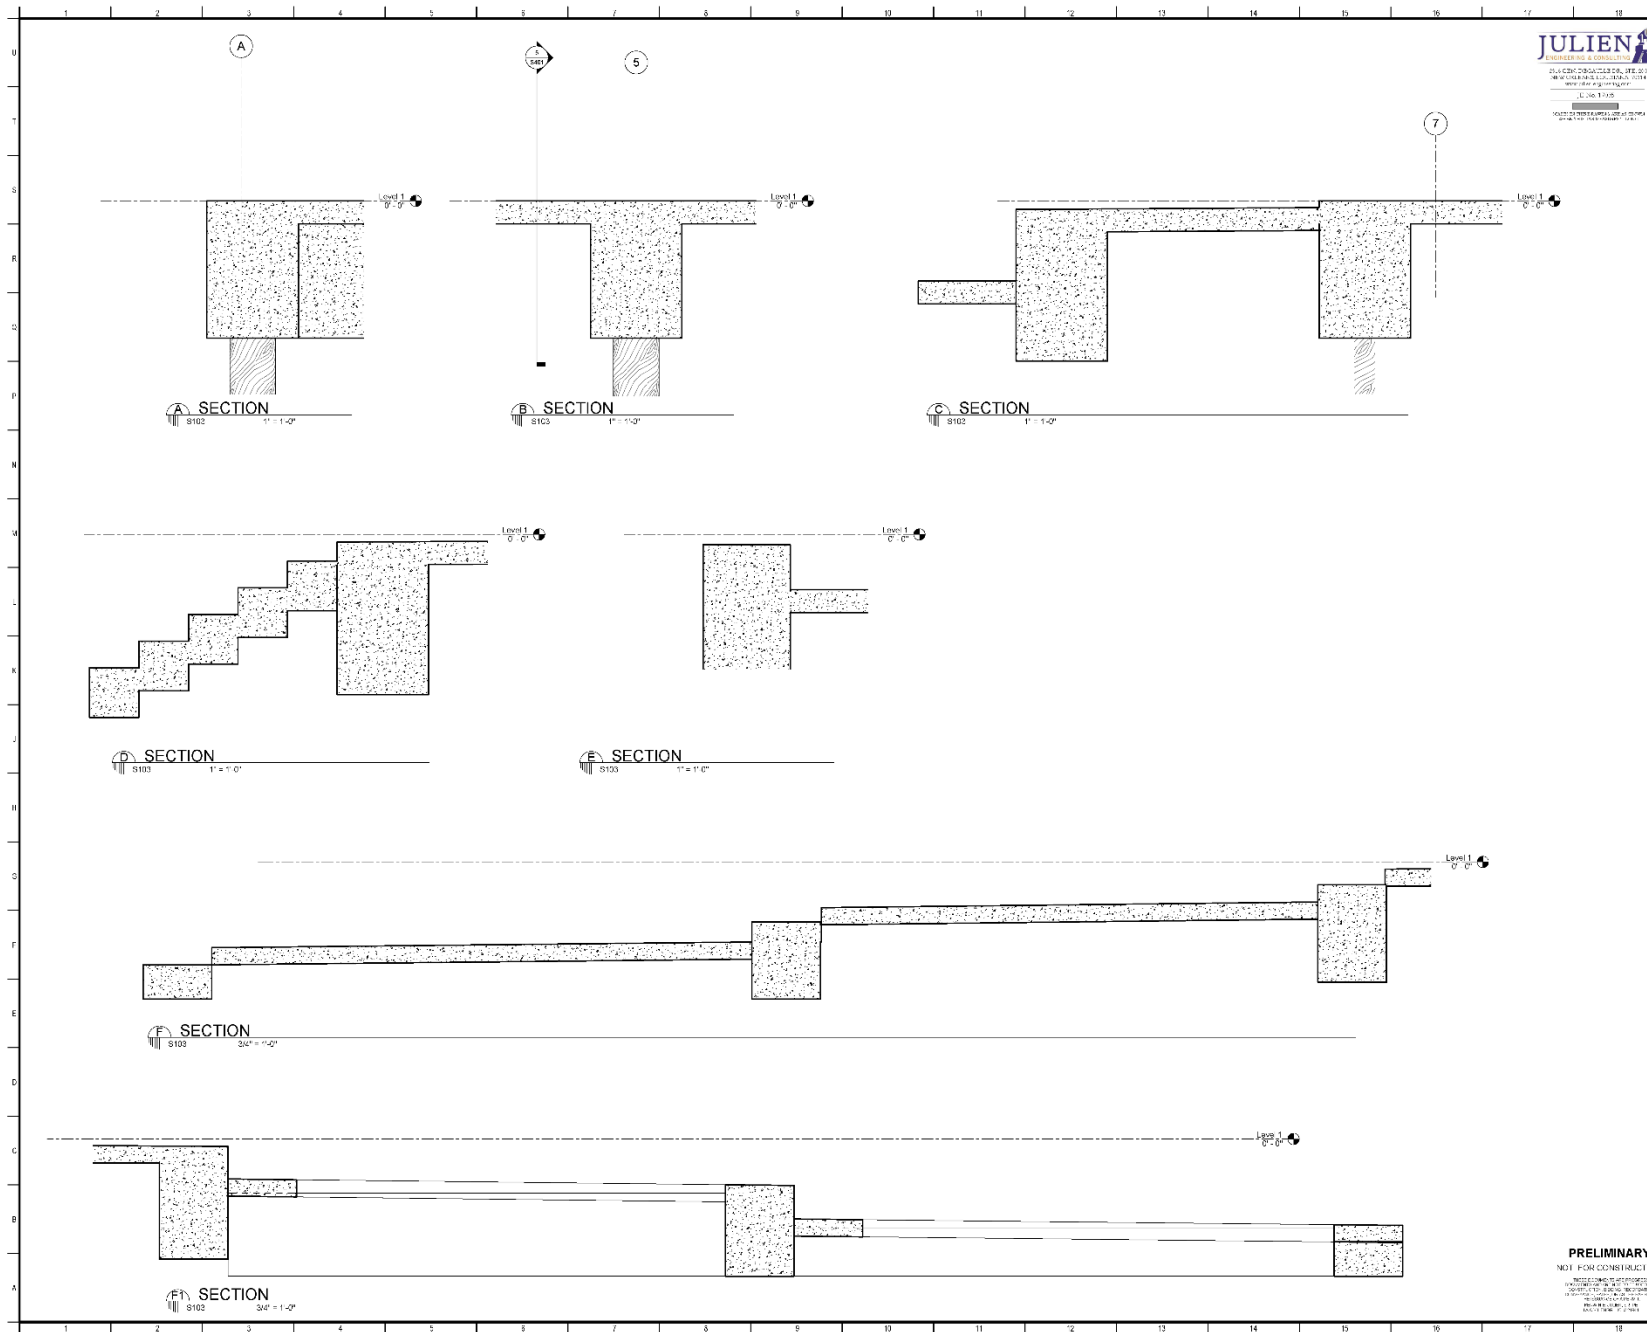

**JULIEN**  
ENGINEERING & CONSULTING  
214 CENTRE DRIVE, STE. 201  
MIAMI, FL 33136  
www.julien-engineering.com  
Tel: 305.375.1111  
Fax: 305.375.1112  
juliene@julien-engineering.com

NOTE: ALL DIMENSIONS ARE IN FEET

No.	Description	Date

REV. 1.01

**Mathes Brierre**  
ARCHITECTS

2800 Charles Avenue, Suite 100  
Miami, FL 33136  
Tel: 305.375.1111  
Fax: 305.375.1112  
mb@mathesbrierre.com

PROJECT FILE

FLORIDA DESIRE  
MULTI-SERVICE CENTER


**PRELIMINARY**  
NOT FOR CONSTRUCTION

DESIGNED BY	DESIGNER	CHECKED BY	CHECKER
DRAWN BY	AUTHOR	DATE	12/20/17

FOUNDATION SECTIONS

PROJECT NO.	77250	SECTION NO.	S103
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NOTES & DIMENSIONS IN FEET

No.	Description	Date

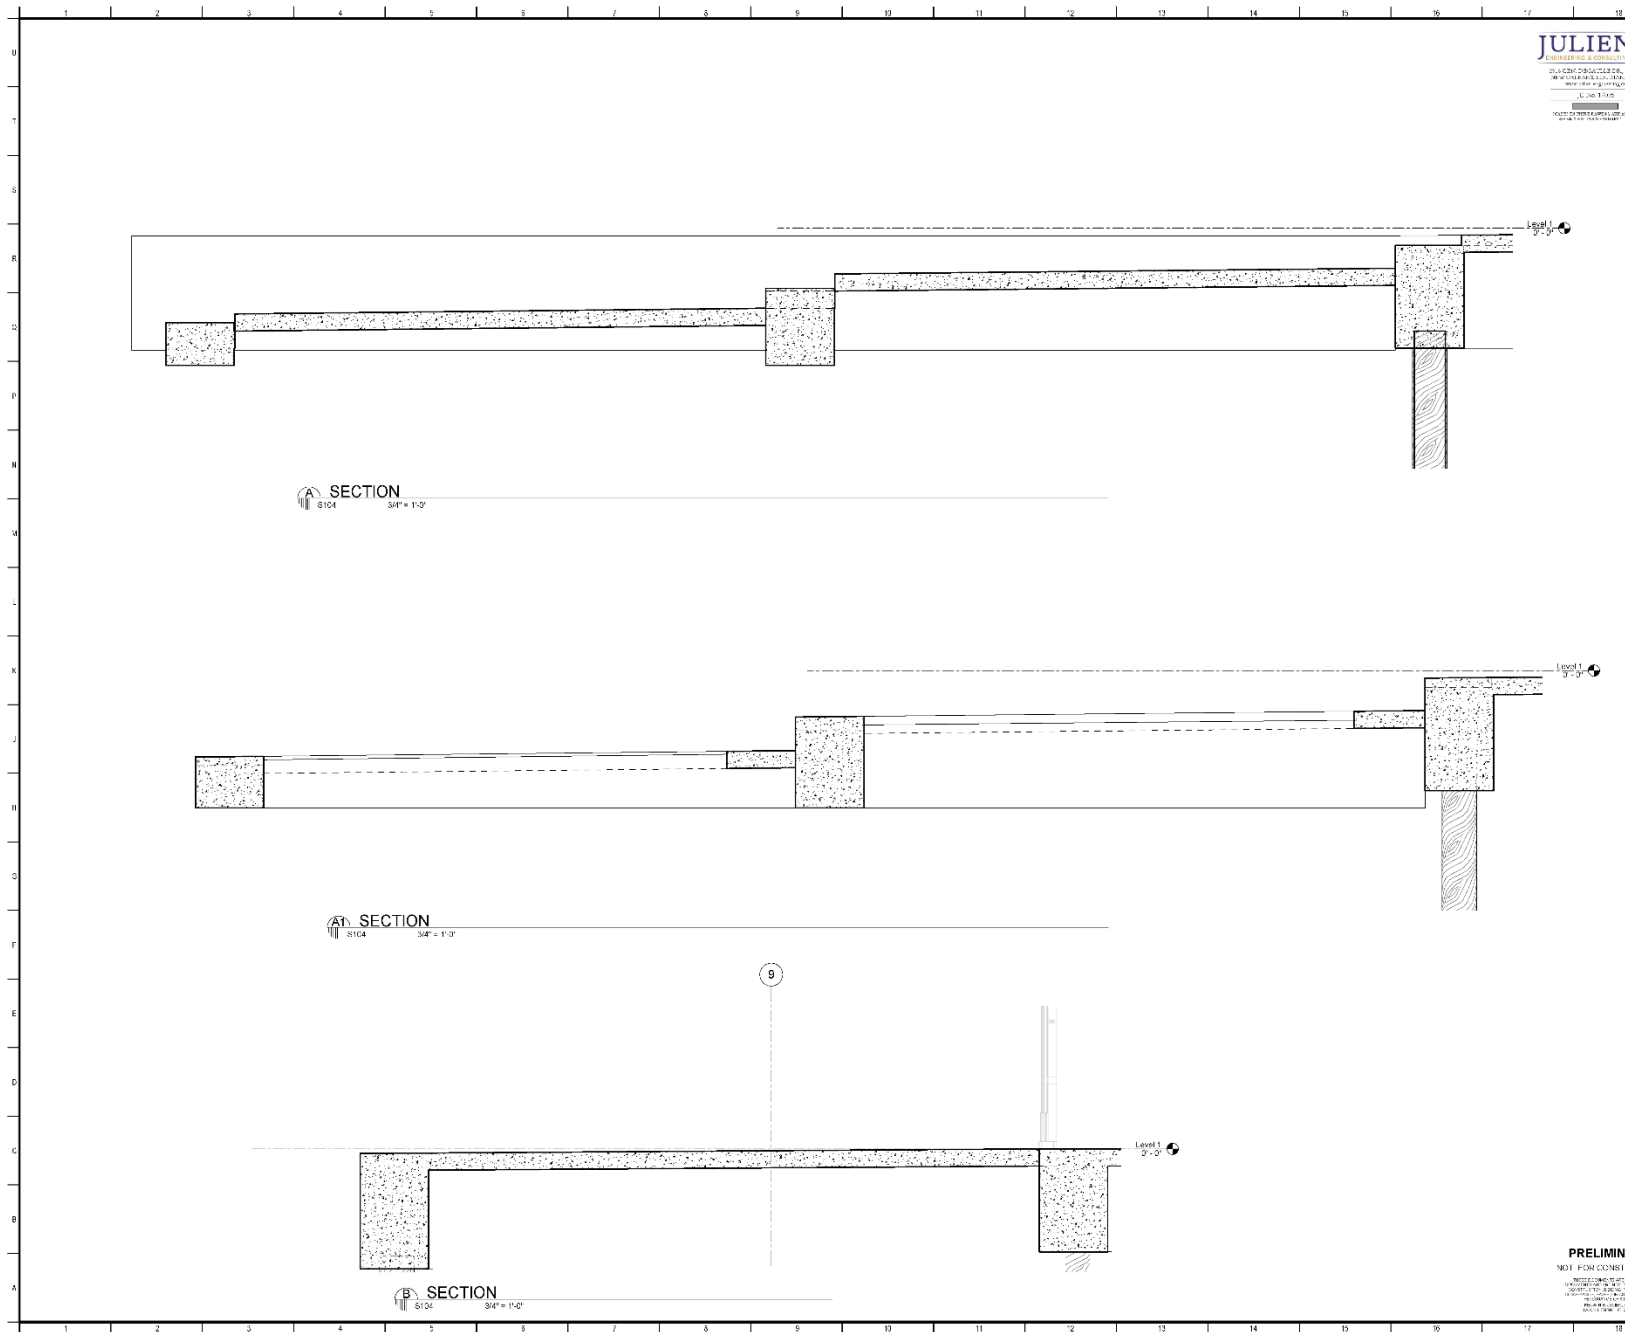FOR P.O.

**Mathes Brierre**  
ARCHITECTS

28 St. Charles Avenue, Fourth Floor  
New Orleans, Louisiana 70130-4002  
Voice: 504.581.8821 Fax: 504.581.1885  
mb@mathesbrierre.com


PROJECT TITLE  
**FLORIDA DESIRE  
MULTI-SERVICE CENTER**

**PRELIMINARY**  
NOT FOR CONSTRUCTION


DESIGNED BY	DESIGNED BY	DESIGNED BY
AUTHOR	AUTHOR	AUTHOR
DATE	DATE	DATE

FOUNDATION SECTIONS

77250	S104
-------	------

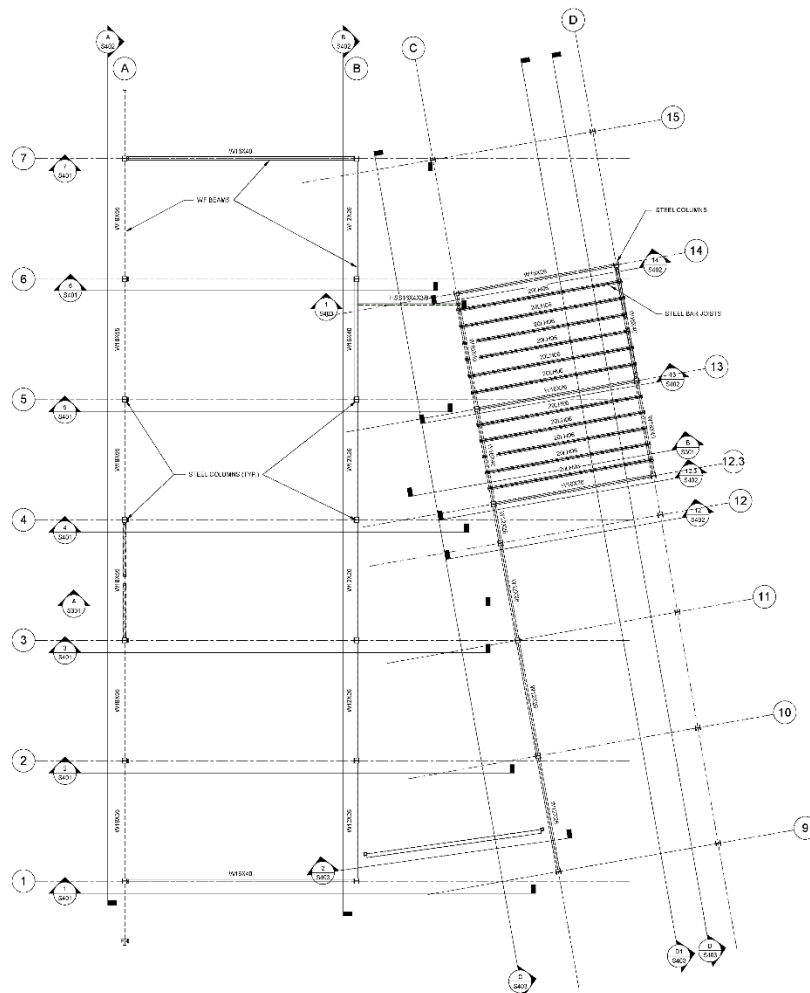

**LOW ROOF FRAMING PLAN**  
S201  
1/8" = 1'-0"

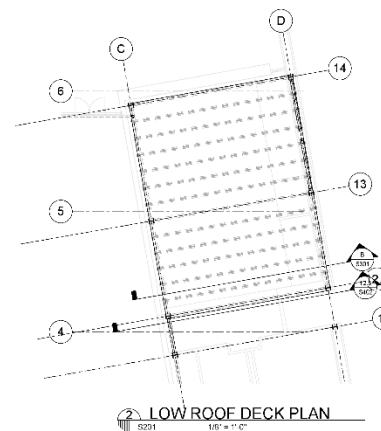

**LOW ROOF DECK PLAN**  
S201  
1/8" = 1'-0"

No.	Description	Date

REV. 1.01

**Mathes Brierre**  
ARCHITECTS

2010 Charles Avenue, Suite 100  
Miami, FL 33136  
Tel: 305.375.1100  
Fax: 305.375.1101  
m.brierre@mathesbrierre.com

PROJECT FILE

**FLORIDA DESIRE  
MULTI-SERVICE CENTER**

**PRELIMINARY**

NOT FOR CONSTRUCTION

DESIGNED BY	DESIGNED BY	DESIGNED BY
AUTHOR	AUTHOR	AUTHOR
DATE	DATE	DATE

LOW ROOF FRAMING PLAN

77250 S201



1. 2019年12月31日，甲公司“应付账款”科目所属各明细科目期末贷方余额如下表所示：

100

281 St. Charles Avenue, P.O. Box 11100  
New Orleans, Louisiana 70178-4100  
Voice: 504.588.9322 Fax: 504.582.1905  
a.chickens@earthlink.net

1. 2015年12月31日，甲公司“应付账款”科目贷方余额为100万元，其中明细科目贷方余额有50万元，借方余额有50万元；“预收账款”科目贷方余额为100万元，其中明细科目贷方余额有80万元，借方余额有20万元；“应收账款”科目借方余额为100万元，其中明细科目借方余额有120万元，贷方余额有20万元。不考虑其他因素，甲公司2015年12月31日资产负债表中“应收账款”项目的金额为（ ）万元。

FLORIDA DESIRE  
MULTI-SERVICE CENTER

DESIGNER	Designer	CHARTERED BY	Choke
LEADER	Author	DATE	12-5-2001

ROOF FRAMING PLAN

77250	S301
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DATE &amp; SIGNIFYING DATE

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201 St. Charles Avenue, Party Floor  
New Orleans, Louisiana 70178-4100  
Voice: 504.588.9302 Fax: 504.582.1305  
a.chibbaro@nato-ncs.org

2002年10月

FLORIDA DESIRE  
MULTI-SERVICE CENTER

PRELIMINARY  
NOT FOR CONSTRUCTION

ROOF DECK PLAN

Roof Deck Plan

10'-0"

10'-0"


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
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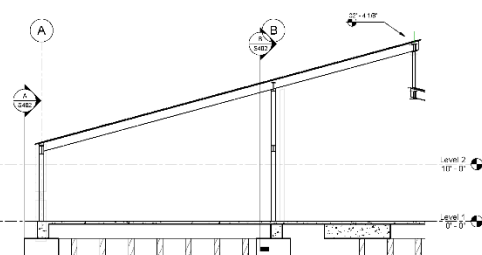
ROOF DECK

ROOF DECK


77250	S302
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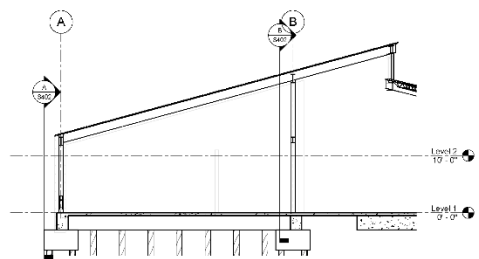
 Framing Elevation - Grid 1




**2 Framing Elevation - Grid 2**

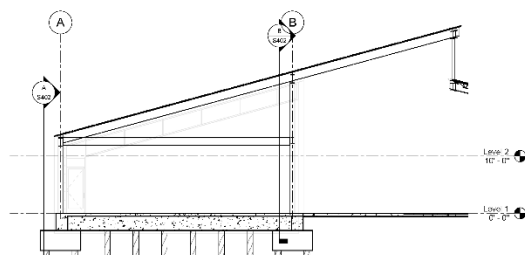


3 Framing Elevation - Grid 3  
S401 1/8" = 1'-0"

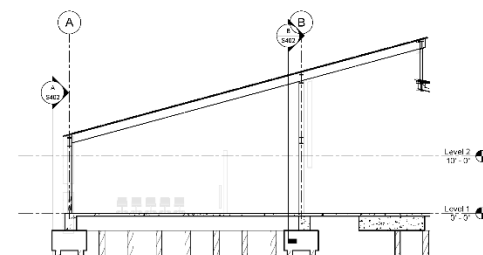


**4 Framing Elevation - Grid 4**

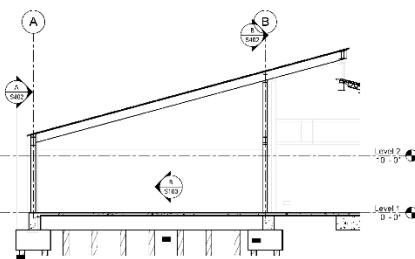


5 Framing Elevation - Grid 5  
3401 10'0" = 1'-0"

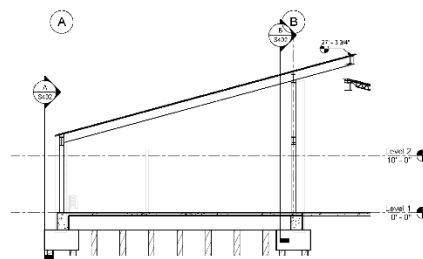


6 Framing Elevation - Grid 6  
S401 1/8" = 1'-0"

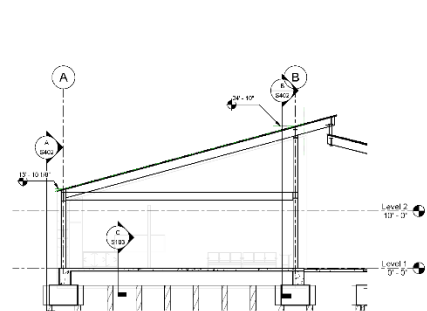


 Framing Elevation - Grid 7

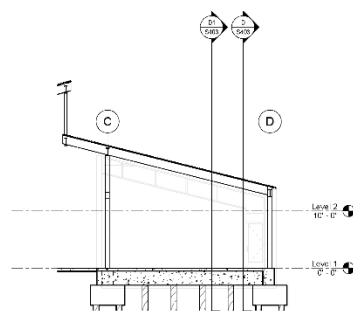

9 Framing Elevation - Grid 9  
S401 1/8" = 1'-0"

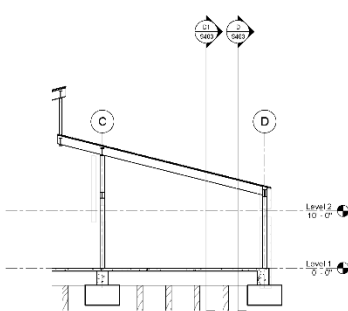

10 Framing Elevation - Grid 10

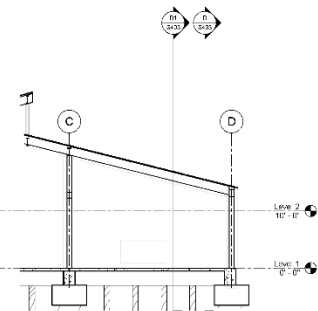

**Framing Elevation - Grid 11**

No.	Description	Date

(2017-2018)

**Mathes Brierre**  
ARCHITECTS

281 St. Charles Avenue, Party #8 at 7:00p  
New Orleans, Louisiana 70119-4150  
Voice: 504.588.9352, Fax: 504.582.1305  
a.chilensky@aol.com

CALL 800.368.3838

FLORIDA DESIRE  
MULTI-SERVICE CENTER


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DRAWN BY	Author	DATE	12-6-2001

**PRELIMINARY**  
NOT FOR CONSTRUCTION






FRAMING ELEVATIONS

77250

[illegible]

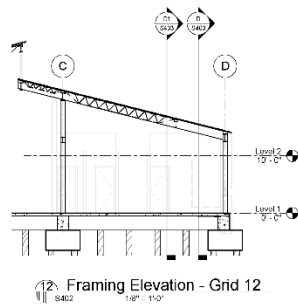

12.3 Framing Elevation - Grid 12.3  
S402 1/8" = 1'-0"

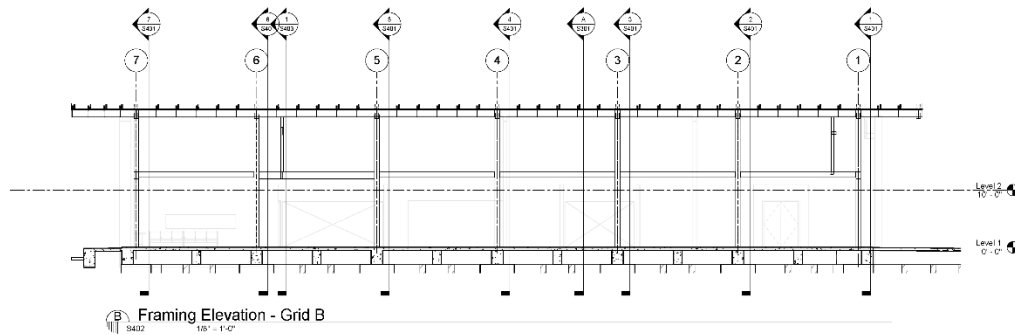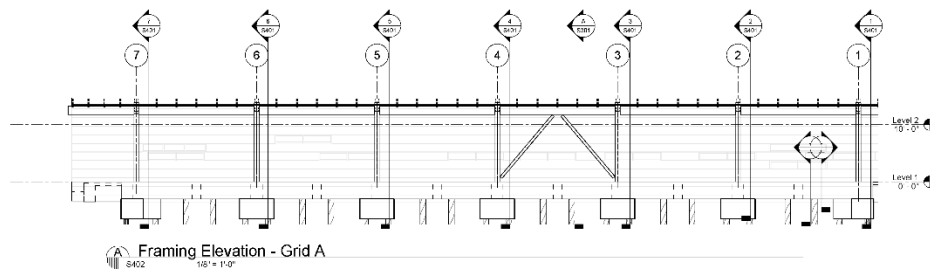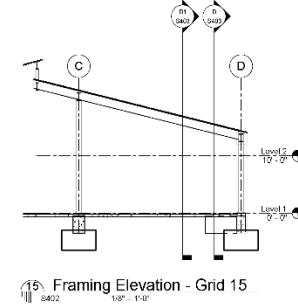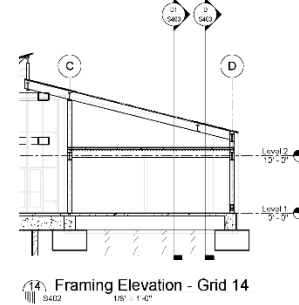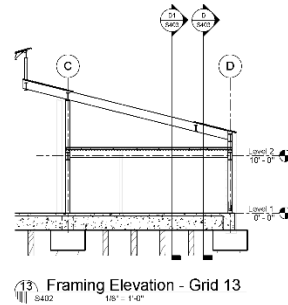

No.	Description	Date

REV. 1.01

**Mathes Brierre**  
ARCHITECTS  
2818 Collins Avenue, Suite 100  
Miami Beach, Florida 33140  
Tel: 305.555.1882 Fax: 305.555.1885  
mb@mathesbrierre.com

PROJECT FILE

FLORIDA DESIRE  
MULTI-SERVICE CENTER


**PRELIMINARY**  
NOT FOR CONSTRUCTION

DESIGNED BY	DESIGNER	CHECKED BY	CHECKER
DRAWN BY	AUTHOR	DATE	
		12/25/2017	

PROJECT NO. 77250 SHEET NO. S402

77250 S402



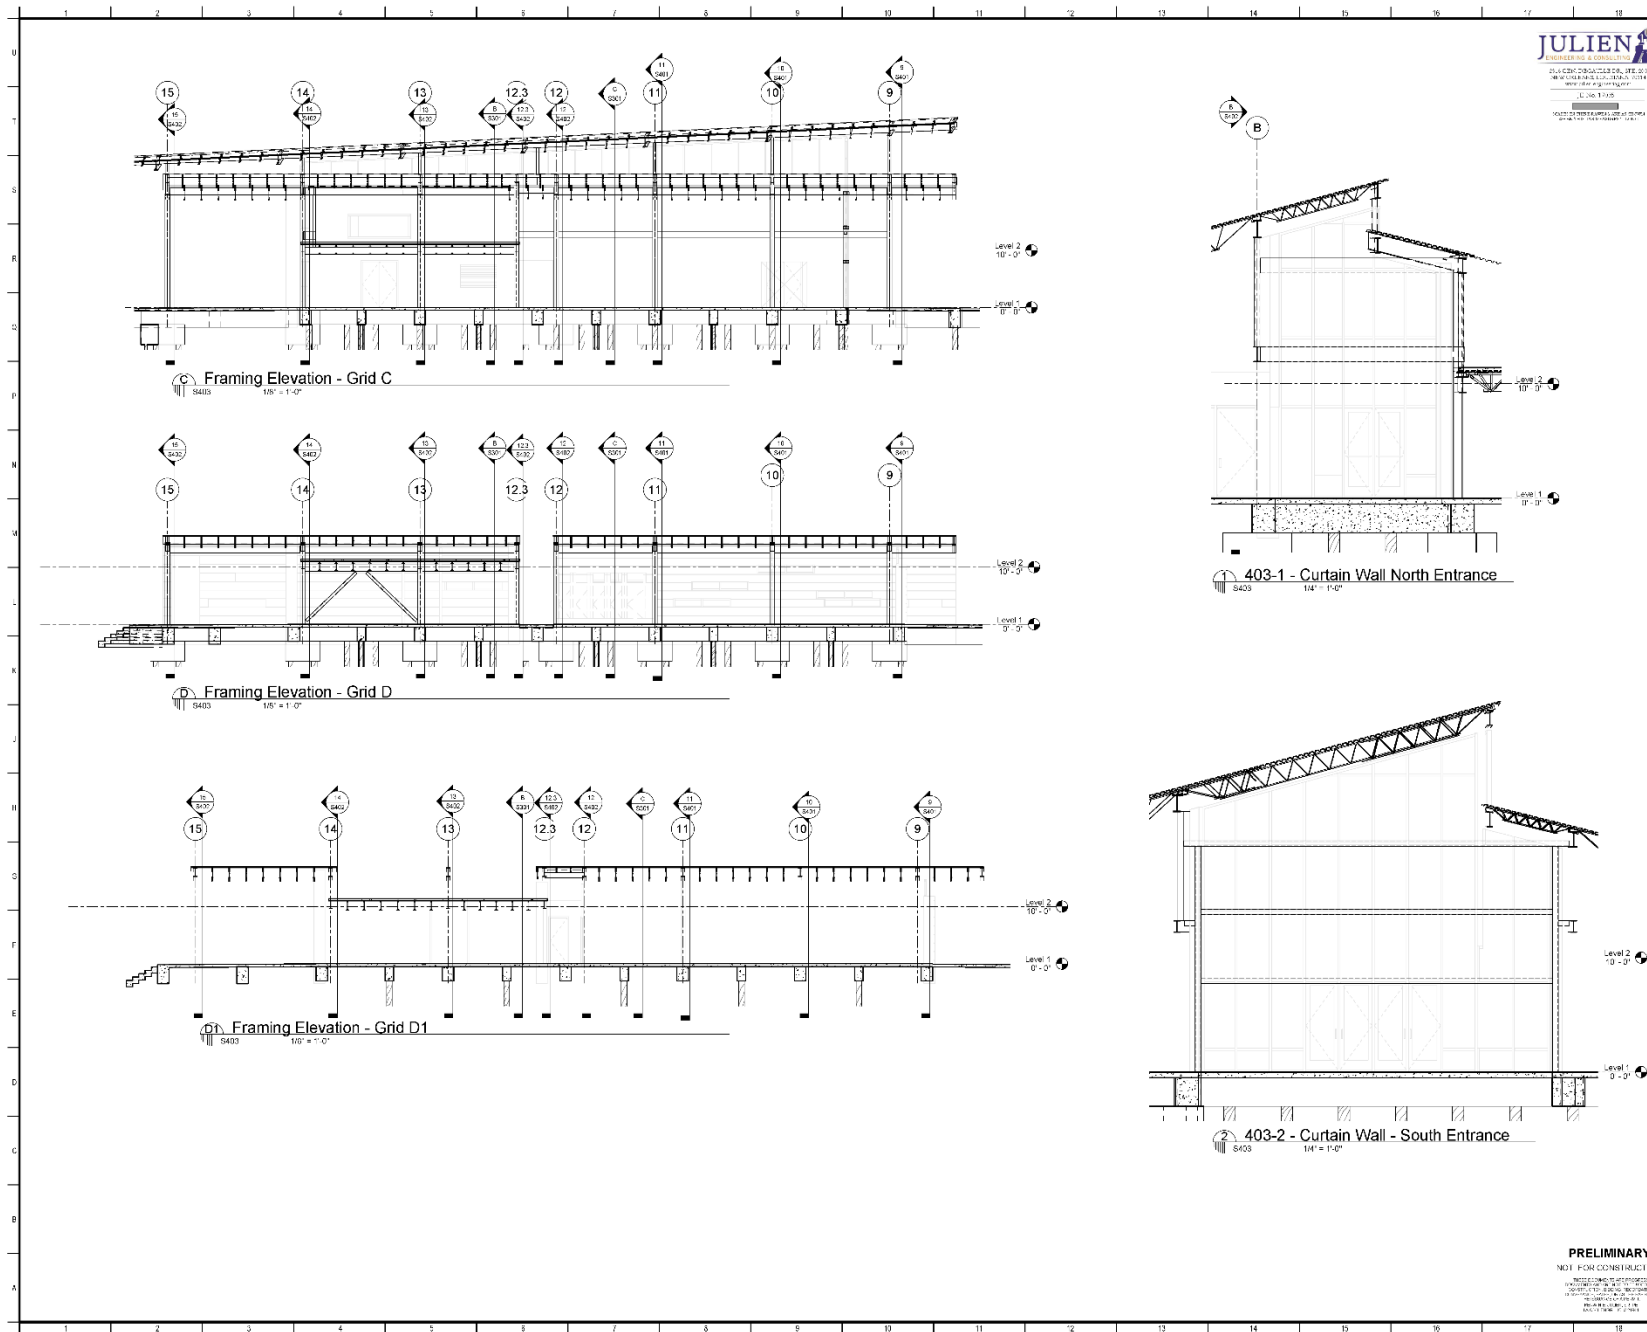

NOTES & SUBMITTAL SHEETS

No.	Description	Date

REV. 1.01

**Mathes Brierre**  
ARCHITECTS

2818 Charles Avenue, Suite 100  
Newport News, Virginia 23606  
Phone: 757.551.5821 Fax: 757.551.5885  
a.brierre@mathesbrierre.com

PROJECT FILE


FLORIDA DESIRE  
MULTI-SERVICE CENTER

**PRELIMINARY**  
NOT FOR CONSTRUCTION

DESIGNED BY	DESIGNER	CHECKED BY	CHECKER
4/14/2017	Author	JUL	12/28/2017

PROJECT NO. 77250 SHEET NO. S403

**77250 S403**

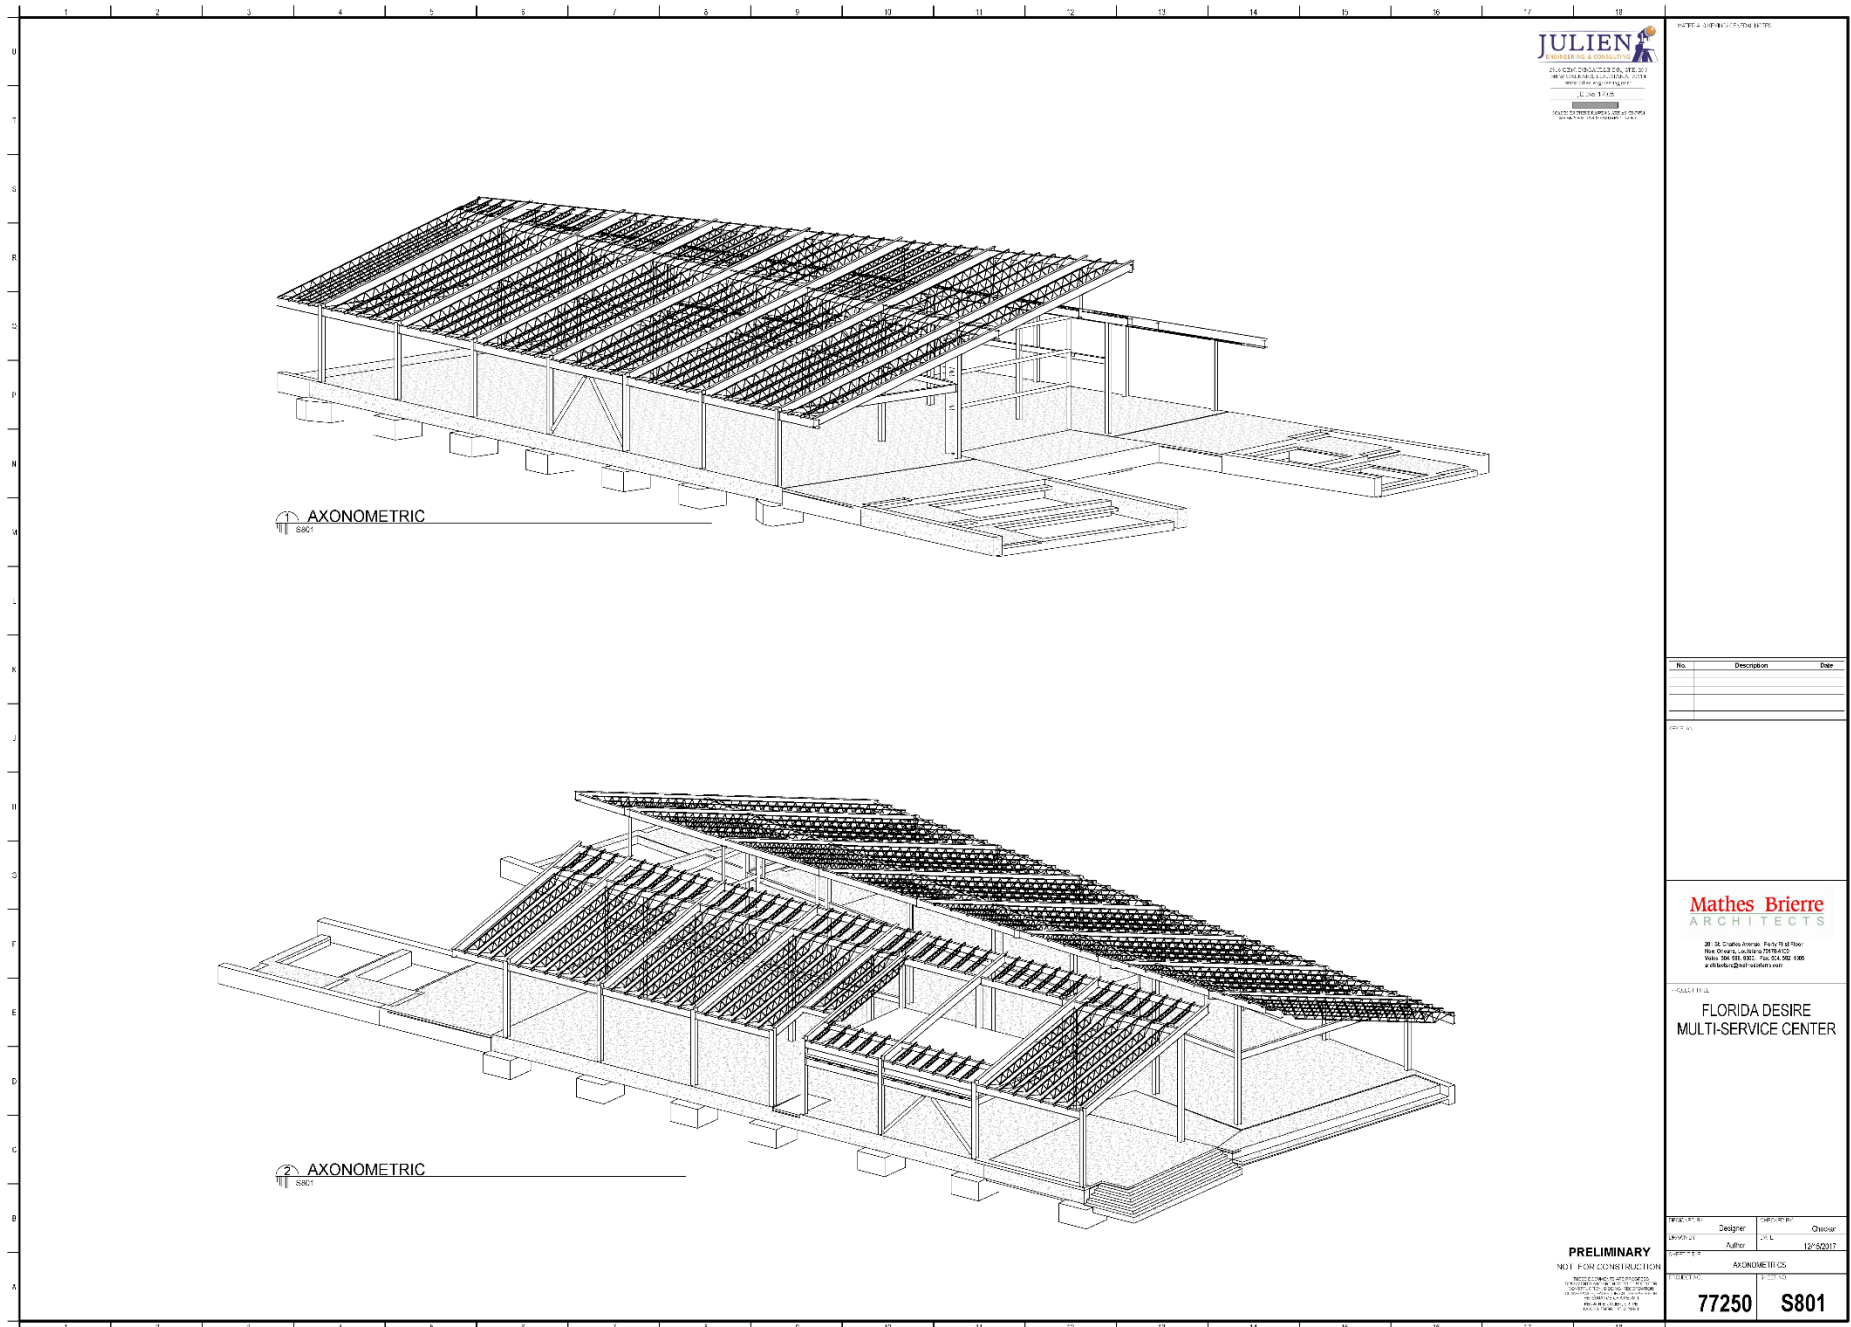

**JULIEN**  
ARCHITECTS & ENGINEERS  
2145 CHATEAU AVENUE, SUITE 201  
SAN FRANCISCO, CA 94134  
www.julienarchitects.com  
TEL: 415.774.1100  
FAX: 415.774.1101  
JULIEN ARCHITECTS & ENGINEERS  
A PROFESSIONAL CORPORATION  
SINCE 1968

NOTES & DIMENSIONS IN FEET

No.	Description	Date

10-1-10

**Mathes Briere**  
ARCHITECTS  
2815 15th Avenue, Suite 100  
San Francisco, CA 94116  
Phone: 415.398.1100 Fax: 415.398.1101  
mathesbriere@gmail.com

FLORIDA DESIRE  
MULTI-SERVICE CENTER

**PRELIMINARY**  
NOT FOR CONSTRUCTION  
REVISIONS TO BE MADE BY THE ARCHITECT  
OR ENGINEER IN CHARGE  
OR BY THE ARCHITECT IN CHARGE  
OR BY THE ARCHITECT IN CHARGE  
OR BY THE ARCHITECT IN CHARGE

REVISION	DESIGNER	DATE	OWNER

PROJECT NO.	AXONOMETRICS
77250	S801







**MECHANICAL FLOOR PLAN**

SCALE: 1/8" = 1'-0"  
0 4' 8' 16'  
SCALE: 1/8" = 1'-0"

**PRELIMINARY  
FOR REVIEW ONLY**  
DECEMBER 14, 2017

No.	Description	Date

REVISIONS

**Infinity**  
Engineering Consultants, LLC  
1111 1st St.  
Gainesville, FL 32601  
727.201.1234

PROJECT & BL

**FLORIDA DESIRE**

DESIGNED BY: M. BITZINGER  
CHECKED BY: T. OQUINN  
PROJECT NO.: MECHANICAL FLOOR PLAN  
SHEET NO.: 77250 M200



**MECHANICAL ROOF PLAN**  
SCALE: 1/8" = 1'-0"  
0 4' 8' 16'  
SCALE: 1/8" = 1'-0"

THESE PLANS HAVE BEEN PREPARED UNDER THE SUPERVISION  
OF MICHAEL P. LEITZINGER, PE (LA NO. 34803) IN THE OFFICE OF  
INFINITY ENGINEERING CONSULTANTS, LLC.

**PRELIMINARY  
FOR REVIEW ONLY**  
DECEMBER 14, 2017

No.	Description	Date

**Infinity**  
Engineering Consultants, LLC  
16000 NW 17th St.  
Miami, FL 33192  
TEL: 305.444.1111  
FAX: 305.444.1112  
WWW.INFINITY-EC.COM

PROJECT TITLE:  
**FLORIDA DESIRE**

DESIGNED BY	ENGINEER
DRAWN BY	DATE
CHECKED BY	PROJECT NO.
PROJECT NO.	77250 M201

**77250 P100**

2

**77250 P100**





THESE PLANS HAVE BEEN PREPARED UNDER THE SUPERVISION OF MICHAEL P. LEITZINGER, P.E. (LA NO. 34803) IN THE OFFICE OF INFINITY ENGINEERING CONSULTANTS, LLC.

**PRELIMINARY  
FOR REVIEW ONLY**  
DECEMBER 14, 2017

No.	Description	Date
1	REVISED	12/14/17


**Infinity**  
Engineering Consultants, LLC  
16000 N. 17th Ave.  
Suite 100  
Tucson, AZ 85745  
(520) 298-1000

PROJECT #111

FLORIDA DESIRE

DESIGNED BY T. O'QUINN  
CHECKED BY M. LEITZINGER  
PROJECT NO. 77250  
SHEET NO. P200

77250 P200

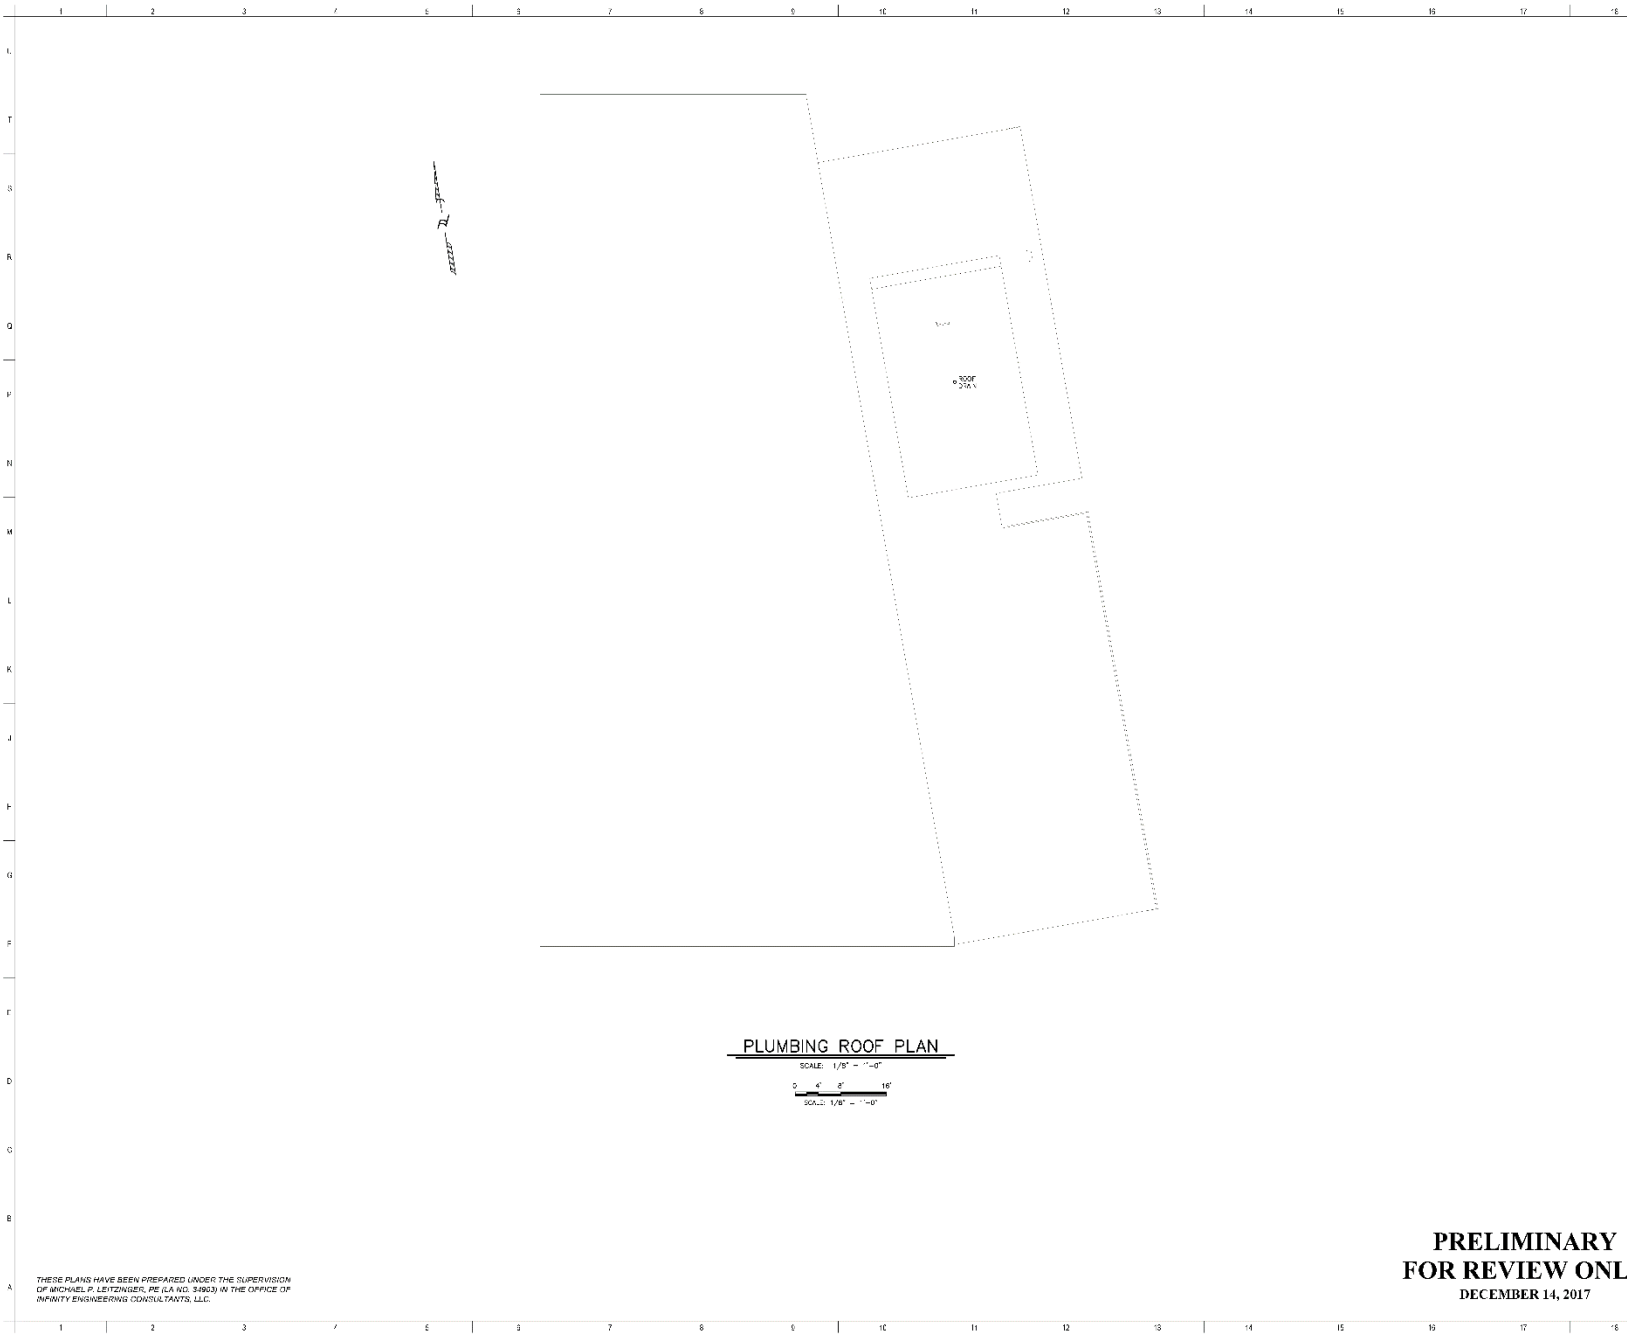

**PLUMBING ROOF PLAN**

SCALE: 1/8" = 1'-0"

0 4' 8' 16'

SCALE: 1/8" = 1'-0"

THESE PLANS HAVE BEEN PREPARED UNDER THE SUPERVISION  
OF MICHAEL P. LEITZINGER, PE (LA NO. 34803) IN THE OFFICE OF  
INFINITY ENGINEERING CONSULTANTS, LLC.

**PRELIMINARY  
FOR REVIEW ONLY**  
DECEMBER 14, 2017

PROJECT: FLORIDA DESIRE

No.	Description	Date

BY: T. O'QUINN

**Infinity**  
Engineering Consultants, LLC  
16000 N. 17th St.  
Suite 100  
Miami, FL 33180  
(305) 444-1111  
www.infinityeng.com

PROJECT: FLORIDA DESIRE

FLORIDA DESIRE

DESIGNED BY: MICHAEL P. LEITZINGER  
CHECKED BY: T. O'QUINN  
DATE: 12/14/17  
PROJECT: PLUMBING ROOF PLAN  
SHEET: 1C

**77250 P201**





































### PLAN DRAWING SYMBOLS (CONTD)

- [illegible]

COLOR CODE ABBREVIATIONS

MR	6' 11"
DR	WHITE
RI	4LB
CI	CAREER
DI	0 2/20/01
DL	2001
AS	ANALYST
W	W/LEAD
F BK	RED BASE W/BLACK TRACER

— — — — — 2000 2001 2002 2816 281

 FLOOR RECEPTACLE  
 FLOOR RECEPTACLE WITH VOLTAGE  
 20-250 TURNING OFF OR ON  
 LIGHTING AND RECEPTACLE DISTRIBUTION  
 DIFFRACTION HORN  
 DIFFRACTION HORN WITH VOLTAGE  
 HORN WITH 1000 HZ  
 HORN WITH 1000 HZ AND VOLTAGE  
 MICROPHONE  
 MICROPHONE WITH VOLTAGE  
 SPEAKER  
 SPEAKER WITH VOLTAGE  
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|---|--|
| NOISE CEILING   | (V) MICROPHONE OUTLET - CEILING MOUNTED            |
| EMERGENCY   | (V) MICROPHONE OUTLET - WALL MOUNTED               |
|   | (V) MICROPHONE OUTLET - FLOOR MOUNTED              |
|   | (V) SOUND SYSTEM CONNECTION - FLUSH FLOOR OUTLET   |
| WALL CROWBARING<br>TO SHOWN UNIT<br>E. MARKING 212 IN<br>P. | (A) SOUND SYSTEM CONNECTION - NON-INSULATED OUTLET |
|   | (N) SPEAKER - OFF THE WALL                         |
|   | (N) SPEAKER - WALL MOUNTED                         |
|   | (T) INTERCOM STATION - CEILING MOUNTED             |
|   | (T) INTERCOM STATION - WALL MOUNTED                |

1-11-70W CLINT - FPCV12 7-81-47 (H E1-1) 25  
DIRECTED BY THE JAMES BETH CAT 6 243 75 70

- [illegible]

### DESCRIPTION

[illegible]

No.	Description	Date

**Infinity**  
Engineering Consultants, LLC  
10000 N. 10th St., Suite 100  
Scottsdale, AZ 85258  
Phone: 480.345.1111  
Fax: 480.345.1112  
www.infinityeng.com

FLORIDA DESIRE

14 SEP 1972 1016 117 C.F. ER  
 DRAFTER T. O. CLINE  
 JLL HLL  
 ELECTRICAL GENERAL NOTES & LEGENDS  
 PROJECT NO SHEET NO.

77250 E100

THESE PLANS HAVE BEEN PREPARED UNDER THE SUPERVISION  
OF GREGORY J. LINTINGER, PE (LA NO. 23878) IN THE OFFICE OF  
INFINITY ENGINEERING CONSULTANTS, LLC.





F.

T

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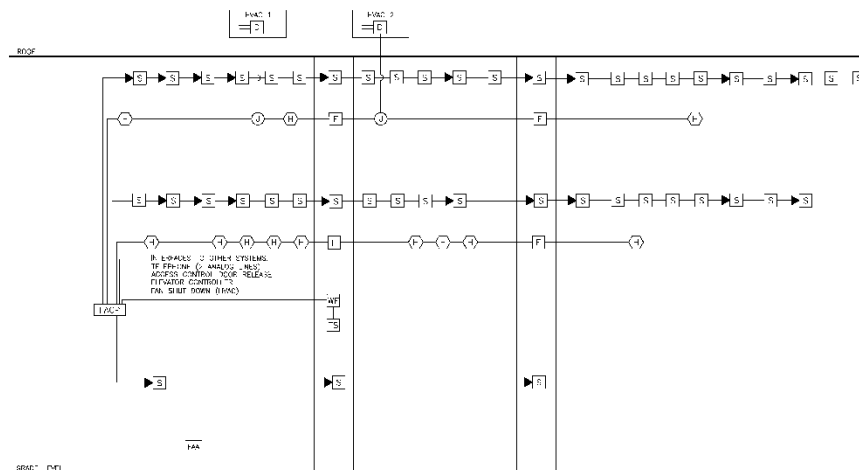
E

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A



No.	Description	Date
1		



PROJECT: FL


FLORIDA DESIRE

**PRELIMINARY  
FOR REVIEW ONLY**  
DECEMBER 14, 2017

DESIGNED BY: T. O. QUINN  
CHECKED BY: C. P. SP  
PROJECTED BY: C. P. SP  
PROJECTED BY: C. P. SP

**77250 E201**

THESE PLANS HAVE BEEN PREPARED UNDER THE SUPERVISION  
OF GREGORY J. LUTINGER, PE (LA NO. 23878) IN THE OFFICE OF  
INFINITY ENGINEERING CONSULTANTS, LLC.

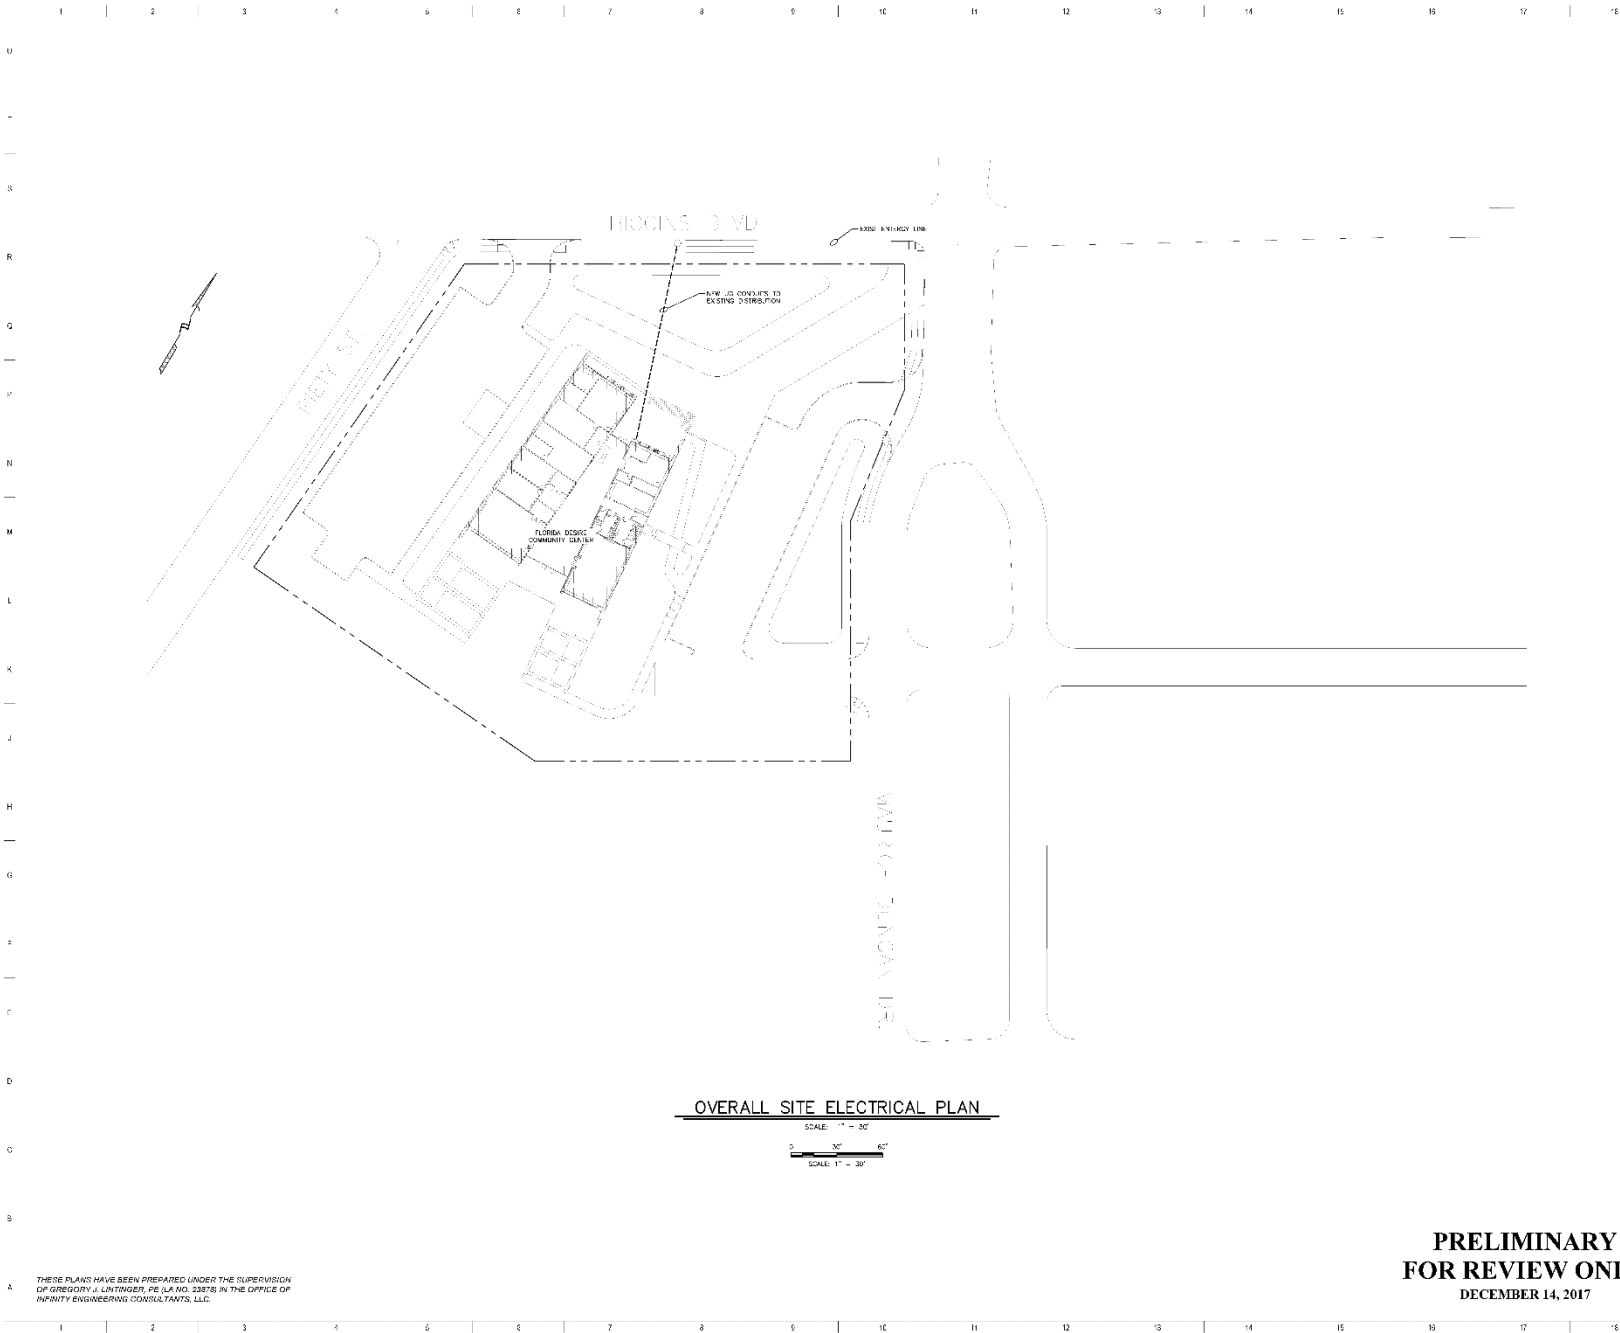

INFINITY ENGINEERING CONSULTANTS, LLC

No.	Description	Date

REVISIONS

**Infinity**  
ENGINEERING CONSULTANTS, LLC  
1111 N. 11TH ST.  
SUITE 100  
FORT WORTH, TX 76102  
817.335.1111

PROJECT & BILL

FLORIDA DESIRE

**PRELIMINARY  
FOR REVIEW ONLY**  
DECEMBER 14, 2017

DESIGNED BY: C. P. S. R.  
CHECKED BY: T. G. QUINN  
DRAWN BY: T. G. QUINN  
PROJECT NO.: 77250 E300

77250 E300





THESE PLANS HAVE BEEN PREPARED UNDER THE SUPERVISION  
OF GREGORY J. LINTINGER, P.E. (LA NO. 23878) IN THE OFFICE OF  
INFINITY ENGINEERING CONSULTANTS, LLC.

**BUILDING LIGHTING PLAN**

SCALE: 1/8" = 1'-0"  
0' 5' 10'  
1/8" = 1'-0"

**PRELIMINARY  
FOR REVIEW ONLY**  
DECEMBER 14, 2017

No.	Description	Date

REV 01



PROJECT #11

FLORIDA DESIRE

DESIGNED BY	CHECKED BY	C.P.S.R.
DRAWN BY	G.A.E.	
DATE	11/14	
PROJECT NO.	BUILDING LIGHTING PLAN	SHEET NO.

**77250 E302**





**ELECTRICAL ROOF PLAN**  
SCALE: 1/8" = 1'-0"  
0 4' 8' 16'  
SCALE: 1/8" = 1'-0"

THESE PLANS HAVE BEEN PREPARED UNDER THE SUPERVISION  
OF GREGORY J. LINTINGER, PE (LA NO. 23878) IN THE OFFICE OF  
INFINITY ENGINEERING CONSULTANTS, LLC.

**PRELIMINARY  
FOR REVIEW ONLY**  
DECEMBER 14, 2017

No.	Description	Date

BY: J. L.



PROJECT #111

FLORIDA DESIRE

DESIGNED BY	CHECKED BY	C. P. SR.
DRAWN BY	DATE	
DATE		
PROJECT NO.		

ELECTRICAL ROOF PLAN  
SHEET 1C

**77250 E303**



BRANCH PANEL: LP1											
LOCATION:			VOLTS: 120/208 V <sub>LL</sub>			A.I.C. RATING: 14000KA					
SUPPLY FROM: MDP			PHASES: 3			WAVE TYPE:					
ENCLOSURE: 36 INCH			MINS: 4			MINS: 48 INCH, 400					
ENCLOSURE: 30 NO. UNB						MINS: 48 INCH, 400					
NOTES:											
CRT	CIRCUIT DESCRIPTION	TRIP	POLES	A	B	C	POLES	TRIP	CIRCUIT DESCRIPTION	CRT	
1										2	
3										4	
5										6	
7										8	
9										10	
11										12	
13										14	
15										16	
17										18	
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71										72	
73										74	
75										76	
77										78	
79										80	
81										82	
83										84	
				TOTAL LOAD							
				TCA, AVE:							
LEGEND:											
LOAD CLASSIFICATION			CONNECTED LOAD		DEMAND FACTOR		ESTIMATED DEMAND		PANEL TOTALS		
APPLIANCE - SMALLER UNIT									TOTAL DEMAND, 120V		
CIRCUIT - SMALLER UNIT									TOTAL 15' DEMAND		
CIRCUIT									TOTAL 15' DEMAND		
CIRCUIT									TOTAL 15' DEMAND		
CIRCUIT									TOTAL 15' DEMAND		
NOTES:											

BRANCH PANEL: M/DP											
LOCATION: BLDG 31				VOLTS: 480VAC				A.I.C. RATING: 750			
SUPPLY FROM: M/DP				PHASES: 3				WAVE TYPE:			
ENCLOSURE: 30 INCH				MIN: 4				MIN: 48 INCH, 400			
NOTES:											
CRT	CIRCUIT DESCRIPTION	TRIP	POLES	A	B	C	POLES	TRIP	CIRCUIT DESCRIPTION	CRT	
1	100V 1" - 1"	100 A	3	100A7			3	100 A		2	
3										4	
5										6	
7	100V 1" - 1"	100 A	3	100A7			3	100 A		8	
9										10	
11										12	
13										14	
15										16	
17										18	
19										20	
21										22	
23										24	
				TOTAL LOAD							
				TOTAL AMPS							
LEGEND:											
LOAD CLASSIFICATION		CONNECTED LOAD		DEMAND FACTOR		ESTIMATED DEMAND		PANEL TOTALS			
APPLIANCE - SMALLER UNIT											
CIRCUIT											
CIRCUIT - SMALLER UNIT											
CIRCUIT											
CIRCUIT											
NOTES:											

No.	Description	Date

ELITE-1




PROJECT NAME:

FLORIDA DESIRE


PRELIMINARY  
FOR REVIEW ONLY  
DECEMBER 14, 2017

DATE: 12/14/17  
PROJECT: PANELSCHEDULE  
DRAWN BY: 77250 E600

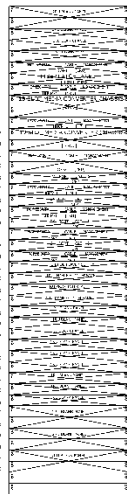


DATA RACK CABINETS

NO.	DESCRIPTION	QUANTITY	UNIT	NOTES
1	1" DIA. STEEL ROD	10	EA	FOR HANGING
2	1/2" DIA. STEEL ROD	10	EA	FOR HANGING
3	1/4" DIA. STEEL ROD	10	EA	FOR HANGING
4	1/2" DIA. STEEL ROD	10	EA	FOR HANGING
5	1/4" DIA. STEEL ROD	10	EA	FOR HANGING
6	1/2" DIA. STEEL ROD	10	EA	FOR HANGING
7	1/4" DIA. STEEL ROD	10	EA	FOR HANGING
8	1/2" DIA. STEEL ROD	10	EA	FOR HANGING
9	1/4" DIA. STEEL ROD	10	EA	FOR HANGING
10	1/2" DIA. STEEL ROD	10	EA	FOR HANGING
11	1/4" DIA. STEEL ROD	10	EA	FOR HANGING
12	1/2" DIA. STEEL ROD	10	EA	FOR HANGING
13	1/4" DIA. STEEL ROD	10	EA	FOR HANGING
14	1/2" DIA. STEEL ROD	10	EA	FOR HANGING
15	1/4" DIA. STEEL ROD	10	EA	FOR HANGING
16	1/2" DIA. STEEL ROD	10	EA	FOR HANGING
17	1/4" DIA. STEEL ROD	10	EA	FOR HANGING
18	1/2" DIA. STEEL ROD	10	EA	FOR HANGING
19	1/4" DIA. STEEL ROD	10	EA	FOR HANGING
20	1/2" DIA. STEEL ROD	10	EA	FOR HANGING
21	1/4" DIA. STEEL ROD	10	EA	FOR HANGING
22	1/2" DIA. STEEL ROD	10	EA	FOR HANGING
23	1/4" DIA. STEEL ROD	10	EA	FOR HANGING
24	1/2" DIA. STEEL ROD	10	EA	FOR HANGING
25	1/4" DIA. STEEL ROD	10	EA	FOR HANGING
26	1/2" DIA. STEEL ROD	10	EA	FOR HANGING
27	1/4" DIA. STEEL ROD	10	EA	FOR HANGING
28	1/2" DIA. STEEL ROD	10	EA	FOR HANGING
29	1/4" DIA. STEEL ROD	10	EA	FOR HANGING
30	1/2" DIA. STEEL ROD	10	EA	FOR HANGING
31	1/4" DIA. STEEL ROD	10	EA	FOR HANGING
32	1/2" DIA. STEEL ROD	10	EA	FOR HANGING
33	1/4" DIA. STEEL ROD	10	EA	FOR HANGING
34	1/2" DIA. STEEL ROD	10	EA	FOR HANGING
35	1/4" DIA. STEEL ROD	10	EA	FOR HANGING
36	1/2" DIA. STEEL ROD	10	EA	FOR HANGING
37	1/4" DIA. STEEL ROD	10	EA	FOR HANGING
38	1/2" DIA. STEEL ROD	10	EA	FOR HANGING
39	1/4" DIA. STEEL ROD	10	EA	FOR HANGING
40	1/2" DIA. STEEL ROD	10	EA	FOR HANGING
41	1/4" DIA. STEEL ROD	10	EA	FOR HANGING
42	1/2" DIA. STEEL ROD	10	EA	FOR HANGING

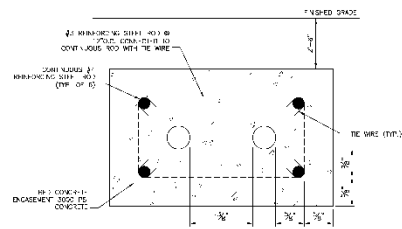


UNDERGROUND DUCTBANK FOR ELECTRICAL SERVICE

SCALE: 1/4" = 1'-0"

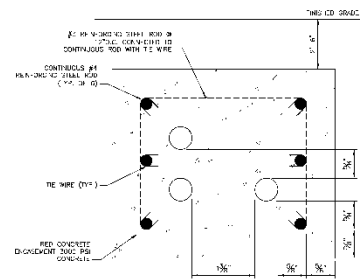


UNDERGROUND DUCTBANK FOR TELECOM SERVICE

SCALE: 1/4" = 1'-0"

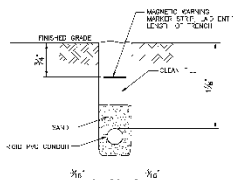

SINGLE CONDUIT

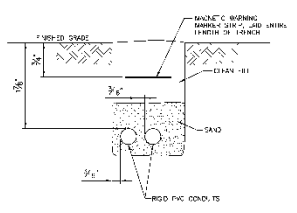

MULTIPLE CONDUITS

UNDERGROUND CONDUIT INSTALLATION WITHOUT CONCRETE ENCASUREMENT

SCALE: 1/4" = 1'-0"

No.	Description	Date
1		

REVISED

**Infinity**  
ENGINEERING CONSULTANTS, LLC  
170117.DWG

PROJECT NO.

FLORIDA DESIRE

**PRELIMINARY  
FOR REVIEW ONLY**  
DECEMBER 14, 2017

DESIGNED BY: T.O. QUINN  
CHECKED BY: M. J. BROWN  
PROJECT NO.: 170117.DWG

77250 E700

THESE PLANS HAVE BEEN PREPARED UNDER THE SUPERVISION OF GREGORY J. LINTNER, P.E. (LA NO. 23878) IN THE OFFICE OF INFINITY ENGINEERING CONSULTANTS, LLC.





SURVEILLANCE NOTES:


- [illegible]

ACCESS CONTROL NOTES:

1. THE CONTRACTOR SHALL PROVIDE AND INSTALL ALL ELEMENTS NECESSARY TO MAKE A COMPLETE AND FUNCTIONAL ACCESS CONTROL SYSTEM AT THE ONA STREET ENTRY TERMINAL.
2. THE FOLLOWER IS THE RFA'S PREFERRED ACCESS CONTROL ELEMENTS BUT NOT LIMITED TO:
- a. S2 NETWORK: THIS ELEMENT SHALL BE TIED INTO THE RFA'S GATEWAY ACCESS CONTROL SYSTEM VIA FIBER OPTIC NETWORK.
  - b. ALL PROXIMITY VEHICLE READERS, DOOR MANAGEMENT, AND A-4 COMPONENTS TO MAKE THIS INSTALLATION COMPLETE SHALL BE MADE A ACCORDANCE WITH RFA'S STANDARDS AND ENGINEER'S RECOMMENDATIONS.

FIBER-OPTIC NETWORK NOTE:

- [illegible]

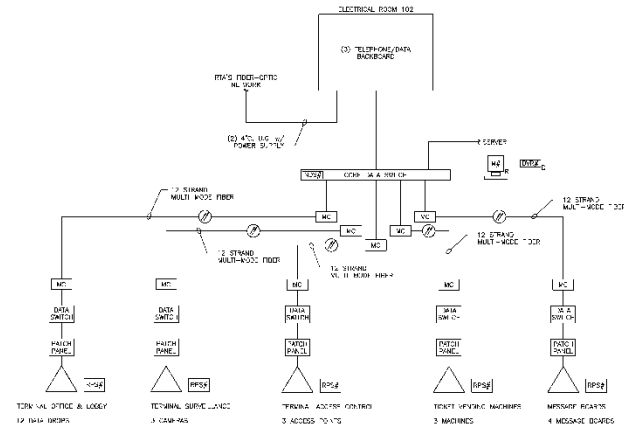

### TELECOMMUNICATIONS RISER DIAGRAM

SONLE: N.T.S.

No.	Descriptions	Date

ref. 26



2000 1709

FGLTFL.

FLORIDA DESIRE

**PRELIMINARY  
FOR REVIEW ONLY**  
DECEMBER 14, 2017

DATE: 10/1/77	PROJECT: 10/1/77	C.F.E.R.
DRAWN BY: T.O. CLINE	DATE:	
SHEET: 111	CONV. & TECH. RISES DIAGRAM	
PROJECTED:	SHEET: 12	

77250 CT200

THESE PLANS HAVE BEEN PREPARED UNDER THE SUPERVISION  
OF GREGORY J. LINTINGER, PE (LA NO. 23878) IN THE OFFICE OF  
INFINITY ENGINEERING CONSULTANTS, LLC.



**COMM. & TECH FLOOR PLAN**

SCALE: 1/8" = 1'-0"  
1/16" = 1'-0"

**PRELIMINARY  
FOR REVIEW ONLY**  
DECEMBER 14, 2017

THESE PLANS HAVE BEEN PREPARED UNDER THE SUPERVISION  
OF GREGORY J. LINTINGER, PE (LA NO. 23878) IN THE OFFICE OF  
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No.	Description	Date
1		


**Infinity**  
Engineering Consultants, LLC  
16000 N. 170th St.  
Suite 100  
Tomball, TX 77375  
(281) 351-1111

PROJECT #11

FLORIDA DESIRE

DESIGNED BY	CHECKED BY	C.P.S.R.
DRAWN BY	DATE	
DATE	DATE	
PROJECT NO.	PROJECT NAME	

**77250 CT300**

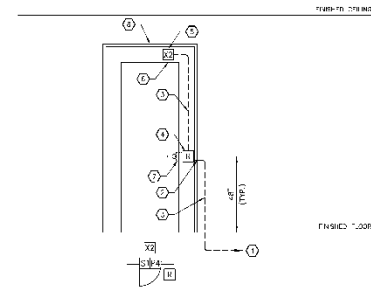

ACCESS CONTROL NOTES:

- [illegible]

CFNR-2A1 NOTES:

1. DETAIL REPRESENTS TYPICAL REQUIREMENTS. SEE TERMINAL BUILDING COMM. & "C" I PLAN TOP EXACT ROOM REVIEWS AT EACH DOOR.
2. REFERENCE COMM. & TECH SYMBOL LEGEND FOR DEVICE CONDUIT AND RACEWAY REQUIREMENTS.

### ACCESS CONTROL DETAIL

SCALE: NLS

ref. 24



**PRELIMINARY  
FOR REVIEW ONLY**  
DECEMBER 14, 2017

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INFINITY ENGINEERING CONSULTANTS, LLC.





[illegible]

A - 18/2 KLU TWST 2-1 FOR SAC DATA  
 B - 16/2 KLU - 100N 2-1 FOR 24V32  
 C - 14/2 ORANGE TWSTED FOR STROBE  
 D - 16/2 YELLOW TWSTED SHIELDED FOR SPEAKERS  
 E - 15/2 30-11 TWSTED SHIELDED FOR ANHOLD 36122 2B A  
 F - 16/2 30-11 TWSTED SHIELDED FOR 2-1 100 4000-5

ALL WTC TYPE FPLP AND INSTALLED IN METALLIC CONDUIT

ALL WIRING MUST BE FREE OF GROUNDS, SHIELDED CONDUCTOR DRAIN WIRES MUST BE WELD CONTINUOUS TO GROUND. THE GROUND MUST BE FREE OF GROUNDS. WIRE DRAIN WIRE IDENTIFICATION IS REQUIRED. WIRING AROUND CONDUCTORS AND TAPE ORIENTED UT ZING FOR RESISTORS SHOULD READ FOR RESISTOR WHEN READ WITH A METER AND EACH CONDUCTOR SHOULD READ OPEN TO GROUND FOLLOWING DRAIN WIRE.



FLORIDA DESIRE

PRELIMINARY  
FOR REVIEW ONLY  
DECEMBER 14, 2017

11/20/94 10:2                      11/20/94 10:2                      C. F. ER  
 DFGW4Er                      637F  
 T. O. CLINA  
 WILLILL  
 FIRE ALARM RISER DIAGRAM  
 PROJECT NO.                      SHEET 12.

77250 FA200

THESE PLANS HAVE BEEN PREPARED UNDER THE SUPERVISION  
OF GREGORY J. LINTINGER, PE (LA NO. 23878) IN THE OFFICE OF  
INFINITY ENGINEERING CONSULTANTS, LLC.



## **Appendix C**

### **8-Step Decision Making Process**



**FLOODPLAIN 8-STEP PLANNING DOCUMENT**  
**CONSTRUCTION OF A NEW FLORIDA DESIRE MULTI-SERVICE CENTER**  
**ORLEANS PARISH**  
**ENVIRONMENTAL ASSESSMENT**  
**FEMA 1603-DR-LA**

Executive Order 11988 - FLOODPLAIN MANAGEMENT

Executive Order 11990 - WETLAND PROTECTION

**Date:** 8 January 2018

**Prepared by:** Laurel Rohrer, Floodplain Specialist

**Applicant:** City of New Orleans

**Project Title:** Construction of a New Desire Florida Multi-Service Center

**Project Location:**

Northwest Corner	Latitude: 29.994273 N	Longitude: -90.033362 W
Northeast Corner	Latitude: 29.994619 N	Longitude: -90.032273 W
Southeast Corner	Latitude: 29.993714 N	Longitude: -90.032092 W
Southwest Corner	Latitude: 29.993632 N	Longitude: -90.033521 W

Hurricane Katrina, DR-1603, impacted Orleans Parish Louisiana and resulted in a presidentially declared major disaster. The City of New Orleans (CNO, the Applicant), including the community centers in the Desire neighborhood, were damaged by storm flooding and wind. These facilities were deemed eligible for rehabilitation by the Federal Emergency Management Agency (FEMA) Public Assistance Grant Program. The objective of this program is to provide assistance to State, Tribal and local governments, and certain types of private nonprofit organizations, so that communities can quickly respond to, recover from, and mitigate major disasters and emergencies.

The Applicant has requested, through the State of Louisiana Governor's Office of Homeland Security and Emergency Preparedness (LA GOHSEP), that FEMA provide disaster assistance consisting of federal grant funds in accordance with the provisions of the Stafford Act. FEMA has determined that the CNO is eligible for federal disaster public assistance and that CNO's community facilities are eligible for repairs.

Consequently, in accordance with 44 C.F.R. § 206.203(d)(1), the CNO has requested an Improved Project, which will allow funds to restore the pre-disaster function of the Desire Florida Community Center in a more suitable location. The pre-disaster function and services of the Desire neighborhood's damaged community center would be maintained.

For the current request, CNO proposes to construct a new approximately 10,000 square foot Desire Florida Multi-Service Center on an approximate 3 acre lot with a public parking areas. The proposed structures would meet all Federal, State, and local codes and would be compliant with the Americans with Disabilities Act (ADA) and have onsite parking for staff and visitors. The construction contract would be issued in compliance with the FEMA procurement regulations. The project would be constructed in conformity with applicable conditions of all required permits.

FEMA is preparing a National Environmental Policy Act (NEPA) Environmental Assessment (EA), incorporated by reference herein, to analyze potential environmental impacts of the proposed project, including those affecting facilities in the base floodplain and protection of wetlands. FEMA will use the findings in the EA to determine whether to prepare an Environmental Impact Statement (EIS) or a Finding

of No Significant Impact (FONSI), and to support the floodplain and wetland “eight-step” planning and public participation requirements in 44 C.F.R. Part 9.

44 C.F.R. 9.6 details an eight-step process that decision-makers must use when considering projects that have potential impacts to or within the floodplain. The eight-step process assesses the action with regard to human susceptibility to flood harm and impacts to wetlands. The eight-step analyzes principle flood problems, risks from flooding, history of flood loss, and existing flood protection measures. The process includes public notice and opportunity for the public to have early and meaningful participation in decision-making and alternative selection. In conjunction with the EA development, the eight-step process formulates and describes considered alternatives; determines their practicability; and includes requirements to incorporate measures to minimize and mitigate potential risks from flooding and impacts to wetlands.

### **Regulatory Setting**

Executive Order (E.O.) 11988, Floodplain Management, requires federal agencies to avoid direct or indirect support or development within or affecting the 1% annual chance Special Flood Hazard Area (SFHA) (i.e., the 100-year floodplain) whenever there is a practicable alternative (U.S. President 1977a) (for “Critical Actions,” within the 0.2% annual chance floodplain, i.e., the 500-year floodplain). FEMA’s regulations for complying with E.O. 11988 are found at 44 C.F.R. § 9, Floodplain Management and Protection of Wetlands (1980).

### **Existing Conditions**

In July 2005, prior to Hurricane Katrina, FEMA initiated a series of flood insurance studies for many of Louisiana’s coastal parishes as part of the Flood Map Modernization Effort through FEMA’s National Flood Insurance Fund. These studies were necessary because the flood hazard and risk information shown on the effective Flood Insurance Rate Maps (FIRMs) were developed during the 1970s. Since that time, the physical terrain had changed considerably, including the significant loss of wetland areas. After Hurricanes Katrina and Rita, FEMA expanded the scope of work to include all of coastal Louisiana. The magnitude of impacts caused by the two (2) hurricanes reinforced the urgency to obtain additional flood recovery data for the coastal zones of Louisiana. More detailed analysis was possible because new data obtained after the hurricanes included information on levees and levee systems, new high-water marks, and new hurricane parameters.

During an initial post-hurricane analysis, FEMA determined that the 100-year or 1% annual chance storm flood elevations on FIRMs for many Louisiana communities, referred to as Base Flood Elevations (BFEs), were too low. FEMA created recovery maps showing the extent and magnitude of the surges from Hurricanes Katrina and Rita, as well as information on other storms over the past 25 years. The 2006 advisory flood data shown on the recovery maps for the Louisiana-declared disaster areas indicated high-water marks surveyed after the storm, flood limits developed from these surveyed points, and Advisory Base Flood Elevations, or ABFEs. These recovery maps and other advisory data were developed to assist parish officials, homeowners, business owners, and other affected citizens with their recovery and rebuilding efforts. Orleans Parish ABFE Maps (DHS 2006) are currently used by the Orleans Parish NFIP community for floodplain management purposes.

Updated preliminary flood hazard maps from an intensive five-year mapping project guided by FEMA were provided to all Louisiana coastal parishes. These maps, released in early 2008, known as Preliminary Digital Flood Insurance Rate Maps (DFIRMs), were based on the most technically advanced flood insurance studies ever performed for Louisiana, followed by multiple levels of review. The DFIRMs provided communities with a more scientific approach to economic development, hazard mitigation planning, emergency response, and post-flood recovery.

The USACE has completed and certified the new Hurricane and Storm Damage Risk Reduction System (HSDRRS) for the Greater New Orleans area (DHS 2011). This 350-mile system of levees, floodwalls, surge barriers, and pump stations will reduce the flood risk associated with future storm events. In

September 2011, the USACE provided FEMA with assurances that the HSDRRS is capable of defending against a storm surge with a 1% annual chance of occurrence (DHS 2011). The areas protected include portions of St. Bernard, St. Charles, Jefferson, Orleans, and Plaquemines Parishes. Although the 100-year perimeter system is now complete, additional contracts for armoring and environmental mitigation are either ongoing or have not yet been awarded (DoA 2014). In November 2012, FEMA revised the 2008 preliminary DFIRMs within the HSDRRS to incorporate the reduced flood risk associated with the system improvements. The preliminary DFIRMs were subsequently revised in 2013 and 2014.

The 2014 Revised Preliminary DFIRMs, which became Effective DFIRMs on 30 September 2016, are currently viewed as the best available flood risk data for the Orleans Parish. In many areas, the flood risk has been significantly reduced due to heightened protection. No project should be built to a floodplain management standard that is less protective than what the community has adopted in local ordinances through its participation in the National Flood Insurance Program (DHS 2011).

Orleans Parish enrolled in the NFIP on 3 August 1970. This project is located within a levee-protected area of the 100-year floodplain. Effective DFIRM Panel 22071C0231F, which became effective on 30 September 2016 (*Figure 5*), indicates that a relatively small area along the western boundary of the project site is located in Flood Zone AE (EL -3), an area levee-protected from the base flood but subject to the 1% annual chance flood, i.e. the 100-year floodplain (dark gray areas on the DFIRM). This area would be constructed as a parking area only, and not where the proposed structure would be constructed. The majority of site lot, including the area where the Florida Desire Multi-Service Center would be constructed is located in Flood Zone Shaded "X," an area levee-protected from the base flood but subject to the 0.2% annual chance flood, i.e. the 500-year floodplain, based upon shallow ponding only (light gray areas on the DFIRM). According to Google Earth, ground elevations within the area are approximately 0 feet above sea level (North American Vertical Datum of 1988). In compliance with E.O. 11988, an 8-step process was completed and is included below.

**STEP 1      Determine whether the proposed actions are located in a wetland and/or the 100-year floodplain (500-year floodplain for critical actions [44 C.F.R. § 9.4]), or whether they have the potential to affect or be affected by a floodplain or a wetland (see 44 C.F.R. § 9.7).**

**Alternative 2: Construct a new Florida Desire Multi-Service Center at Higgins Boulevard and Desire Parkway (Preferred Alternative)** - Effective DFIRM Panel: 22071C0231F (dated 30 September 2016) places the majority of the project location in a Shaded "X" Flood Zone (Levee Protected from the Base Flood and partially in an area of the 0.2% annual chance flood from ponding) and a small portion of the project location in an AE (EL -3) Flood Zone (Levee Protected from the Base Flood and partially in an area of the 1% annual chance flood).

A review of the U.S. Fish and Wildlife National Wetland Inventory indicates the proposed project location not is located in a mapped wetland or U.S. waters.

**Alternative 3: Alternative 3 – Construct the new facility at the Pre-Hurricane Katrina location of the Desire facility at Louisa Street and Florida Avenue** - Effective DFIRM Panel 22071C0231F, which became effective on 30 September 2016, indicates that the alternative project site is located in Flood Zone AE (EL -3), an area levee-protected from the base flood but subject to the 1% annual chance flood, i.e. the 100-year floodplain.

A review of the U.S. Fish and Wildlife National Wetland Inventory indicates the proposed project location not is located in a mapped wetland or U.S. waters.

**STEP 2**      **Notify the public at the earliest possible time of the intent to carry out an action in a floodplain or wetland, and involve the affected and interested public in the decision making process (see 44 C.F.R. § 9.8).**

Notice will be or has been provided by: A cumulative public notice was published in the New Orleans *Times Picayune*, Baton Rouge *Advocate*, Lafayette *Daily Advertiser*, Lake Charles *American Press* and the Hammond *Star* on 7-9 November 2005.

**STEP 3**      **Identify and evaluate practicable alternatives to locating the proposed action in a floodplain or wetland (including alternative sites, actions and the "no action" option) [see 44 C.F.R. § 9.9]. If a practicable alternative exists outside the floodplain or wetland, FEMA must locate the action at the alternative site.**

- **Alternative 1: No Action** – Under the “No Action” alternative, there would be no new construction of the Desire Florida Multi-Service Center. Consequently, the Desire neighborhood would continue to have sub-optimal community service facilities, as no new facility would be constructed. “No Action” would forego the opportunity to improve community services for the Desire neighborhood.
- **Alternative 2: Construct a new Florida Desire Multi-Service Center at Higgins Boulevard and Desire Parkway (Preferred Alternative)** - This alternative includes the design, construction, and furniture, fixtures, and equipment (FFE) for the new Desire Florida Multi-Service Center in the Desire neighborhood of New Orleans. The existing lot would be graded to accommodate the new structures and parking lots, and the new structure constructed in the center of the proposed site.

The property proposed for the new Desire Florida Multi-Service Center is currently an undeveloped, cleared, approximately 2.5 acre lot located in the Desire neighborhood of New Orleans. The lot is bordered on the north by Higgins Boulevard, to the east by Desire Parkway, to the south by undeveloped, cleared land, and to the west by Piety Street.

- **Alternative 3 – Construct the new facility at the Pre-Hurricane Katrina location of the Desire facility at Louisa Street and Florida Avenue** - For this alternative, the CNO would reconstruct the new Florida Desire facility at CNO-owned, pre-Hurricane Katrina, location of the Desire Multi-Service Center at the intersection of Louisa Street and Florida Avenue, which is located at 29.984987, -90.036581, in a similar configuration and of similar size to Alternative 2 to serve the needs of Desire community (*Figure 7*). This alternative site is bounded to the north by Industry Street, to east by Piety Street, to the south by Florida Avenue, and to the west by Louisa Street.

**STEP 4**      **Identify the full range or potential direct or indirect impacts associated with, the occupancy or modification of floodplains and wetlands and the potential direct and indirect support of floodplain and wetland development that could result from the proposed action (see 44 C.F.R. § 9.10).**

- **Alternative 1: No Action** – The “No Action” alternative would not entail any construction of the new Desire Florida Multi-Service Center. This course would have no further adverse impacts to the floodplain.
- **Alternative 2: Construct a new Florida Desire Multi-Service Center at Higgins Boulevard and Desire Parkway (Preferred Alternative)** – Alternative 2 was reviewed for possible impacts associated with occupancy or modification to a floodplain. Although the character of the proposed site will change significantly from currently undeveloped and cleared to developed with impervious surfaces, due to the relatively small size of the site, impacts to the nature of the floodplain itself have been



determined to be negligible. Construction of the Desire Florida Multi-Service Center would not significantly affect the functions and values of the 100-year floodplain since these actions would not significantly impede or redirect flood flows.

Per 44 C.F.R. § 9.11(d)(6), no project should be built to a floodplain management standard that is less protective than what the community has adopted in local ordinances through their participation in the NFIP. The Applicant would be required to coordinate with the local floodplain administrator regarding floodplain permit(s) prior to the start of any activities. Per 44 C.F.R. § 9.11(d)(9), for the replacement of building contents, materials, and equipment, where possible disaster-proofing of the building and/or elimination of such future losses should occur by relocation of those building contents, materials, and equipment outside or above the base floodplain.

- **Alternative 3 – Construct the new facility at the Pre-Hurricane Katrina location of the Desire facility at Louisa Street and Florida Avenue** – Alternative 3 was reviewed for possible impacts associated with occupancy or modification to a floodplain. Although the character of the proposed site will change significantly from currently undeveloped and cleared to developed with impervious surfaces, due to the relatively small size of the site, impacts to the nature of the floodplain itself have been determined to be negligible. Construction of the Desire Florida Multi-Service Center would not significantly affect the functions and values of the 100-year floodplain since these actions would not significantly impede or redirect flood flows.

Per 44 C.F.R. 9.11(d)(6), no project should be built to a floodplain management standard that is less protective than what the community has adopted in local ordinances through their participation in the NFIP. The Applicant would be required to coordinate with the local floodplain administrator regarding floodplain permit(s) prior to the start of any activities. Per 44 C.F.R. § 9.11(d)(9), for the replacement of building contents, materials, and equipment, where possible disaster-proofing of the building and/or elimination of such future losses should occur by relocation of those building contents, materials, and equipment outside or above the base floodplain.

#### STEP 5

**Minimize the potential adverse impacts and support to or within floodplains and wetlands to be identified under Step # 4, restore and preserve the natural and beneficial values served by floodplains, and preserve and enhance the natural and beneficial values served by wetlands (see 44 C.F.R. § 9.11).**

The construction of the new Desire Florida Multi-Service Center shall be completed in accordance with all local floodplain ordinances with applicable codes and standards applied to mitigate and minimize adverse effects (compliance with minimum National Flood Insurance Program standards and requirements). In order to minimize indirect impacts (erosion, sedimentation, dust and other construction-related disturbances) to the nearby waters of the United States and well-defined drainage areas surrounding the site, the contractor should implement Best Management Practices (BMPs) that meet the Louisiana Department of Environmental Quality's (LDEQ's) permitting specifications for storm water discharge regulated under §§ 401 and 402 of the CWA, and include the following into the daily operations of the construction activities: silt screens, barriers (e.g., hay bales), berms/dikes, and/or fences to be placed where and as needed.

#### STEP 6

**Reevaluate the proposed action to determine first, if it is still practicable in light of its exposure to flood hazards, the extent to which it will aggravate the hazards to others and its potential to disrupt floodplain and wetland values and second, if alternatives preliminarily rejected at Step # 3 are practicable in light of the information gained in**

**Steps # 4 and # 5. FEMA shall not act in a floodplain or wetland unless it is the only practicable location (see 44 C.F.R. § 9.9).**

The proposed action is the chosen practicable alternative based upon a review of possible adverse effects on the floodplain and community and socioeconomic expectations.

STEP 7

**Prepare and provide the public with a finding and public explanation of any final decision that the floodplain or wetland is the only practicable alternative (see 44 C.F.R. § 9.12).**

A public notice will be published as part of the NEPA Environmental Assessment for the proposed action.

STEP 8

**Review the implementation and post-implementation phases of the proposed action to ensure that the requirements of the order are fully implemented. Oversight responsibility shall be integrated into existing processes.**

Project shall be reviewed by FEMA at grant closeout to ensure the project was completed in accordance with all relevant and applicable floodplain ordinances, codes and standards and that all project actions were undertaken in accordance with terms and conditions stipulated to mitigate and minimize adverse effects in or to the floodplain and wetlands. Approval conditioned on reviews of implementation and post implementation phases to ensure compliance with the order(s).

Project has been reviewed for compliance with 44 CFR Part 9.

## **Appendix D**

### **Agency Correspondence**

**From:** [Rohrer, Laurel](#)  
**To:** ["martinez.eli@epa.gov"](#); ["linda.piper@la.gov"](#)  
**Subject:** SOV request - AI 2532 Construction of a new Desire Florida Multi-Service Center  
**Date:** Friday, January 05, 2018 3:25:00 PM  
**Attachments:** CNO - Desire Florida Multi-Service Center SOW.docx

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U.S. Department of Homeland Security  
Federal Emergency Management Agency FEMA-DR 1603 LA  
1500 Main St.  
Baton Rouge, LA 70802

January 5, 2018

MEMORANDUM TO: See Distribution

SUBJECT: Scoping Notification/Solicitation of Views  
AI 2532 City of New Orleans – Construction of a New Desire Florida Multi-Service  
Center  
New Orleans, LA 70126

Mr. Martinez and Ms. Piper,

FEMA will be preparing an Environmental Assessment (EA) for the above referenced project. To assist us in preparation of the EA, we request that your office review the attached SOV memo, including site location figures, and construction plans for a determination of any formal consultation, regulatory permitting, or other authorization requirements.

The proposed improved project would involve the construction of a new Multi-Service Center in the Desire Neighborhood of New Orleans on a currently underdeveloped site. This facility is being constructed to replace community centers in the Desire area that were damaged as result of Hurricane Katrina. Please see attached SOV memo for details of the proposed project locations and scope of work.

Thank you in advance for your time and attention to this matter.

Distribution: USEPA, LDEQ

Laurel Rohrer (CTR)  
NISTAC Contractor  
Federal Emergency Management Agency  
1100 Robert E. Lee Blvd.  
New Orleans, LA 70124  
(504) 343-5749 (FEMA cell)  
(540) 842-3300 (personal cell)  
Email: [Laurel.Rohrer@associates.fema.dhs.gov](mailto:Laurel.Rohrer@associates.fema.dhs.gov)



1/5/2018

Project: City of New Orleans

Construction of New Desire Florida Multi-Service Center

Parish: Orleans Parish

Latitude/Longitude: Approximate Location of New Multi-Service Center Structure -  
29.993858, -90.032784

### Scope of Work:

#### **(Preferred Action) – Construct a new Desire Florida Multi-Service Center at the Intersection of Higgins Boulevard and Desire Parkway**

This alternative includes the design, construction, and furniture, fixtures, and equipment (FFE) for a new Florida Desire Multi-Service Center building in the Desire neighborhood of New Orleans. The existing project site is currently undeveloped. The lot would be graded as necessary to accommodate the new structure and associated parking lots.

The property proposed for the new Florida Desire Multi-Service Center is currently an undeveloped, but cleared with evidence of possible development that existed on the site previously. The footprint of the proposed project location is depicted in *Figures 1 and 2*. The proposed project site is an approximate 3 acre lot located in the Desire neighborhood of New Orleans. According to the CNO Property Viewer, the Housing Authority of New Orleans (HANO) owns the proposed project lot. The lot is bordered on the north by Higgins Boulevard, to the east by Desire Parkway, to the south by undeveloped, cleared land, and to the west by Piety Street. *Table 1* defines the four (4) corners of the proposed project site.


**Table 1. Four Corners of the Proposed Florida Desire Multi-Service Center Project Site**

Corner	Latitude	Longitude
Northwest	29.994273	-90.033362
Northeast	29.994619	-90.032273
Southeast	29.993714	-90.032092
Southwest	29.993632	-90.033521

Under this Alternative, the CNO would construct a new approximate 10,000 square foot (sf) multi-service center for the use of residents of the Desire neighborhood. The proposed multi-service center would provide community meeting rooms, multi-purpose rooms, a commercial kitchen, and office space. The proposed structure would meet all Federal, State, and local codes, be compliant with the Americans with Disabilities Act (ADA) and have onsite parking for staff and visitors. *Figure 3* depicts a schematic plan showing the locations of the proposed structure and associated parking lots.




As shown in *Figure 3*, the proposed multi-service center would be constructed in the center of the site. Parking areas for a total of 57 vehicles would be constructed to the east and west of the multi-service center. The purpose multi-service center would be accessible from both Higgins Boulevard and Desire Parkway via four driveways. Maintained green spaces would be constructed on the property near the parking areas. There would be several areas where clusters of trees would exist on the site.

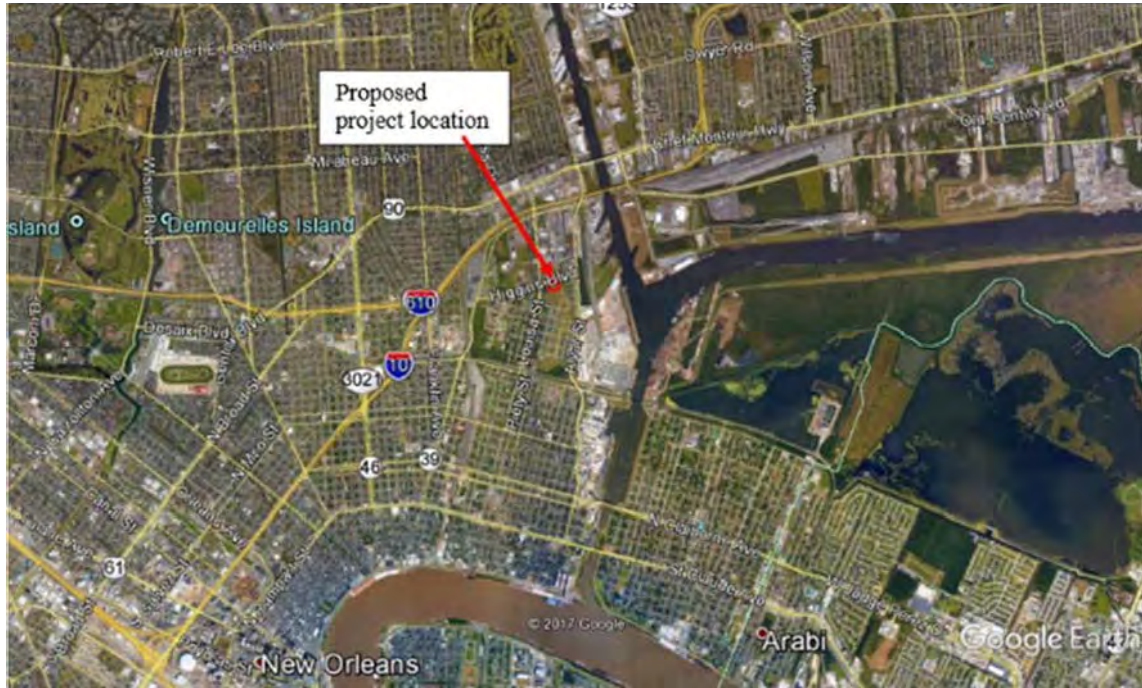

**Figure 1 – Project Vicinity in the Desire neighborhood of Orleans Parish. The proposed project area is depicted in red. (Image Source – Google Earth 2018)**



**Figure 2 - Aerial overview of the proposed project footprint, outlined in red. (Image Source - Google Earth 2018)**

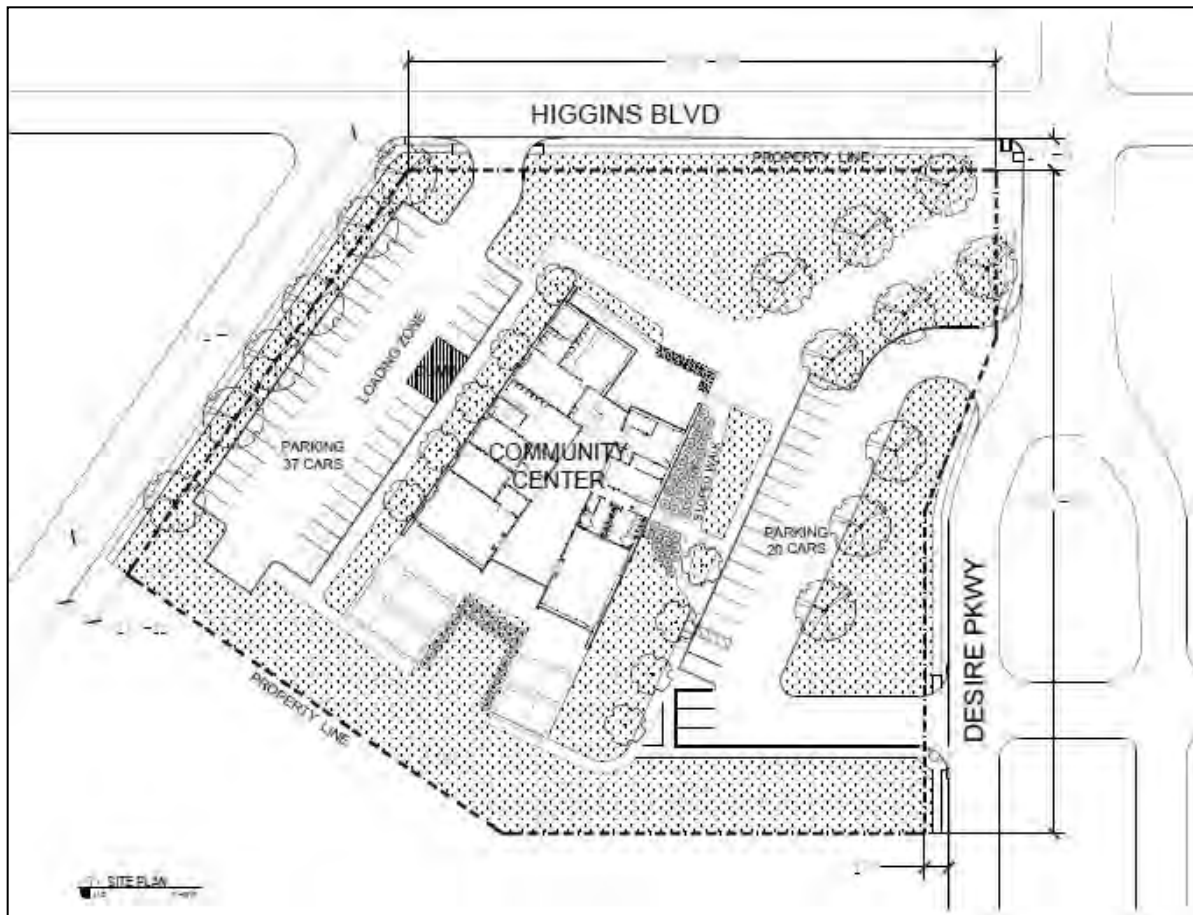

**Figure 3– Schematic image depicting the overall proposed project plans. (Image Source: City of New Orleans Florida Desire Multi-Purpose Center, Design Development Submittal, Mathes Brierre Architects.)**





State of Louisiana  
DEPARTMENT OF NATURAL RESOURCES  
OFFICE OF COASTAL MANAGEMENT

01/12/2018

FEMA  
1100 ROBERT E. LEE BLVD  
NEW ORLEANS, LA 70124

**RE: P20180021, Solicitation of Views  
FEMA**

**Description:** The scope of work includes the design, construction, and furniture, fixtures, and equipment (FFE) for a new Florida Desire Multi-Service Center building in the Desire neighborhood of New Orleans. The existing project site is currently undeveloped. The lot would be graded as necessary to accommodate the new structure and associated parking lots.

**Location:** Lat. 29° 59' 38.06"N / Long. 90° 01' 58.02"W; 3400 Desire Parkway, New Orleans, LA 70126.

**Orleans Parish, LA**

Dear Laurel Rohrer:

We have received your Solicitation of Views for the above referenced project, which has been found to be inside the Louisiana Coastal Zone. In order for us to properly review and evaluate this project, we require that a complete Coastal Use Permit Application packet (Joint Application Form, locality maps, project illustration plats with plan and cross section views, etc.) along with the appropriate application fee be submitted to our office. Using your complete application, we can provide you with an official determination, and begin the processing of any Coastal Use Permit that may be required for your project. You may obtain a free application packet by calling our office at (225) 342-7591 or (800)-267-4019, or by visiting our website at <http://www.dnr.state.la.us/crm/coastmgt/cup/cup.asp>.

We recommend that, during your planning process, you make every effort to minimize impacts to vegetated wetlands. As our legislative mandate puts great emphasis on avoiding damages to these habitats, in many cases the negotiations involved in reducing such disturbances and developing the required mitigation to offset the lost habitat values delay permit approval longer than any other factor. Additionally, the following sensitive features may require additional processing time by the appropriate resource agencies:

Orleans Levee District - Permittee shall, prior to commencement of the herein permitted activities, contact Billy Wall (phone: 225-342-9423, email: [billy.wall@la.gov](mailto:billy.wall@la.gov)) to determine if a construction permit will be required from the local levee district. This determination does not eliminate the need to obtain a permit from the United States Army, Corps of Engineers or any other Federal, state or local

approval that may be required by law. The drawings submitted with your referenced application are attached hereto and made a part of the record. If you have any questions regarding this authorization, please contact our office (225) 342-7591 or (800) 267-4019.


CPRA Master Plan features (PO-0063) Lake Pontchartrain & Vicinity located within project buffer zone.

Chitimacha Aboriginal Grounds - The area where the project is located is all part of the aboriginal homelands of the Chitimacha Tribe of Louisiana. As such, large villages, burial sites, and sacred sites were in place in that entire area. If at any time during the course of the work, any traditional cultural properties are discovered, Permittee shall immediately contact Kimberly S. Walden (Cultural Director) or Melanie Aymond (Research Coordinator) at (337) 923-9923 or (337) 923-4395. Office hours are Monday through Thursday from 7:30 A.M. - 5:00 P.M. and on Friday between 7:30 A.M. - 11:30 A.M. If traditional cultural properties are discovered on the weekend or after business hours, the notification shall be made the next business morning.

Should you desire additional consultation with our office prior to submitting a formal application, we recommend that you call and schedule a pre-application meeting with our Permit Section staff. Such a preliminary meeting may be helpful, especially if a permit application that is as complete as possible is presented for evaluation at the pre-application meeting.

If you have any questions, would like to request an application packet or would like to schedule a pre-application meeting, please contact Brad Hester at (225) 342-7472 or [brad.hester@la.gov](mailto:brad.hester@la.gov).

Sincerely,

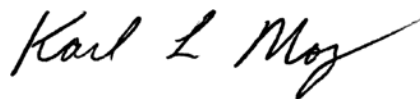A handwritten signature in black ink, appearing to read "Karl L. Morgan". The signature is fluid and cursive, with a long horizontal stroke at the end.

Karl L. Morgan  
Administrator

**Karl L. Morgan/bh**

Attachments

P20180021, Solicitation of Views  
FEMA  
01/12/2018  
Page 3

**Final Plats:**

1) [P20180021](#)      [Final Plats](#)      [01/09/2018](#)

cc: Jessica Diez, OCM w/plats  
Craig Leblanc, Frank Cole, CMD/FI w/plats  
Orleans Parish w/plats





**FEMA**

U.S. Department of Homeland Security  
Federal Emergency Management Agency  
FEMA-1603/1607-DR-LA  
FEMA Louisiana Recovery Office  
Environmental/Historic Preservation  
1500 Main Street  
Baton Rouge, LA 70802

February 21, 2018

Kristin Sanders  
Deputy State Historic Preservation Officer  
Department of Culture, Recreation & Tourism  
1051 North Third Street  
Baton Rouge, LA 70802

**RE: Section 106 Review Consultation, Hurricane Katrina, FEMA-1603-DR-LA**

**Subrecipient:** City of New Orleans

**Undertaking:** Construction of the Desire Florida Multi-Service Center, Corner of Higgins Boulevard & Desire Parkway, New Orleans, Orleans Parish, Louisiana (29.994039, -90.032737)(AI 2546)

**Determination: No Historic Properties Affected**

Dear Ms. Sanders:

The Federal Emergency Management Agency (FEMA) will be providing funds authorized under the Robert T. Stafford Disaster Relief and Emergency Assistance Act, P.L. 93-288, as amended, in response to the following major Disaster Declarations:

FEMA-1603-DR-LA, dated August 29, 2005, as amended.

FEMA, through its Public Assistance Program, proposes to fund the construction of the Desire Florida Multi-Service Center (Undertaking) as requested by the City of New Orleans (Subrecipient). FEMA is initiating Section 106 review for the above referenced properties in accordance with the "Programmatic Agreement Among the Federal Emergency Management Agency, the Louisiana State Historic Preservation Officer, the Governor's Office Of Homeland Security Department of Culture, Recreation & Tourism with the opportunity to consult on the proposed Undertaking. Documentation in this letter is consistent with the requirements in 36 CFR §800.11(d).

**Description of the Undertaking**

The City of New Orleans proposes to construct a building to serve as a Multi-Service Center for the Desire Florida neighborhood. The one-story building will be situated at the corner of Higgins Blvd. and Desire Pkwy. The Undertaking will also include landscaping, utilities, sidewalks, walkways, ADA ramps, retention/detention ponds, and parking areas (Figures 1 and 2.)

### **Area of Potential Effects (APE)**

In accordance with Stipulation II.C.(2) of the 2016 Statewide PA, this letter serves as coordination for the standing structures and archaeological APE. The standing structures APE is limited to the subject property. The archaeological APE measures 3.8 acres (1.5 ha) and takes into account all ground-disturbing activities, including site preparation and construction (Figure 3).

### **Identification and Evaluation**

#### *Standing Structures*

Historic Properties within the APE were identified based on FEMA's review of the National Register of Historic Places (NRHP) database and the Louisiana Cultural Resources Map by FEMA Historic Preservation staff. This data was evaluated by FEMA using the National Register (NR) Criteria.

The proposed project site is a vacant lot. FEMA determined that the proposed site of the Desire Florida Community Center is not located within a listed National Register Historic District (NRHD).

#### *Archaeology*

Upon consultation of data provided by SHPO on February 20, 2018, there are four recorded archaeological sites within ½ mile of the archaeological APE: 16OR348, 16OR349, 16OR350, and 16OR351 (Figure 4). All four sites are historic residences dating from circa 1950. All four were identified by a FEMA post-Katrina walk-over after demolition. None of the sites have been assessed for their eligibility on the NRHP. However, none of these sites are within the Archaeological APE and will not be affected by the construction of the new multi-service center.

The Hardee 1878 map and New Orleans 1891 quad identifies that the APE was originally in backswamp. The New Orleans Northeast 1932 and 1954 quads identify the APE as undeveloped "green space." The New Orleans Northeast 1967 quad has the area platted. No individual Sanborn sheets are available, but the main sheet for Vol. 9, Sheet 0b, 1937-1951, identifies the area is platted, but has no housing information. Historic construction within the APE includes the northwest portion of the Desire public housing development. After the demolition of the housing development in 2003, the archaeological APE was used as a yarding area between 2005 and 2010. The remains of the hard surface used for the yarding can still be seen in Figure 3. The APE is located within the Orleans Parish Low Archaeological Probability Zone. The soils are Convent-Commerce-Sharkey, a recent alluvium.

Based upon available evidence it is unlikely that intact NRHP-eligible archaeological deposits would be recovered during the construction of the Desire Florida Multi-Service Center as the APE was originally backswamp, the only construction was the Desire housing that was demolished in 2003, and after the housing development demolition the area was used for yarding trailers and equipment.

### **Assessment of Effects**

Based on the aforementioned identification and evaluation, FEMA has determined that there are no historic properties as defined in 36 CFR 800.16(l) within the APE. Therefore, FEMA has determined a finding of **No Historic Properties Affected** for this Undertaking and is submitting this Undertaking to you for your review and comment. FEMA requests your comments within 15 days.

2/21/2018

Construction of the Desire Florida Multi-Service Center, New Orleans, Orleans Parish, Louisiana (29.994039, -90.032737) (AI 2546)

We look forward to your concurrence with this determination. Should you have any questions or need additional information regarding this Undertaking, please contact me at (504) 247-7771 or [jerame.cramer@fema.dhs.gov](mailto:jerame.cramer@fema.dhs.gov), or Annette Carroll, Historic Preservation Specialist at (504) 265-1900 or [annette.carroll@fema.dhs.gov](mailto:annette.carroll@fema.dhs.gov), or Richard Williamson, Archaeologist at (504) 908-5372 or [richard.williamson@fema.dhs.gov](mailto:richard.williamson@fema.dhs.gov).

Sincerely,

JERAME J  
CRAMER

Digitally signed by  
JERAME J CRAMER  
Date: 2018.02.21 13:45:27  
-06'00'

Jeramé J. Cramer  
Environmental Liaison Officer  
FEMA-DR-1603-LA, FEMA-DR-1607-LA

CC: File  
Enclosures

No known historic properties will be affected by this undertaking. Therefore, our office has no objection to the implementation of this project. This effect determination could change should new information come to our attention.



Kristin P. Sanders  
Deputy State Historic Preservation Officer

Date 03/07/2018

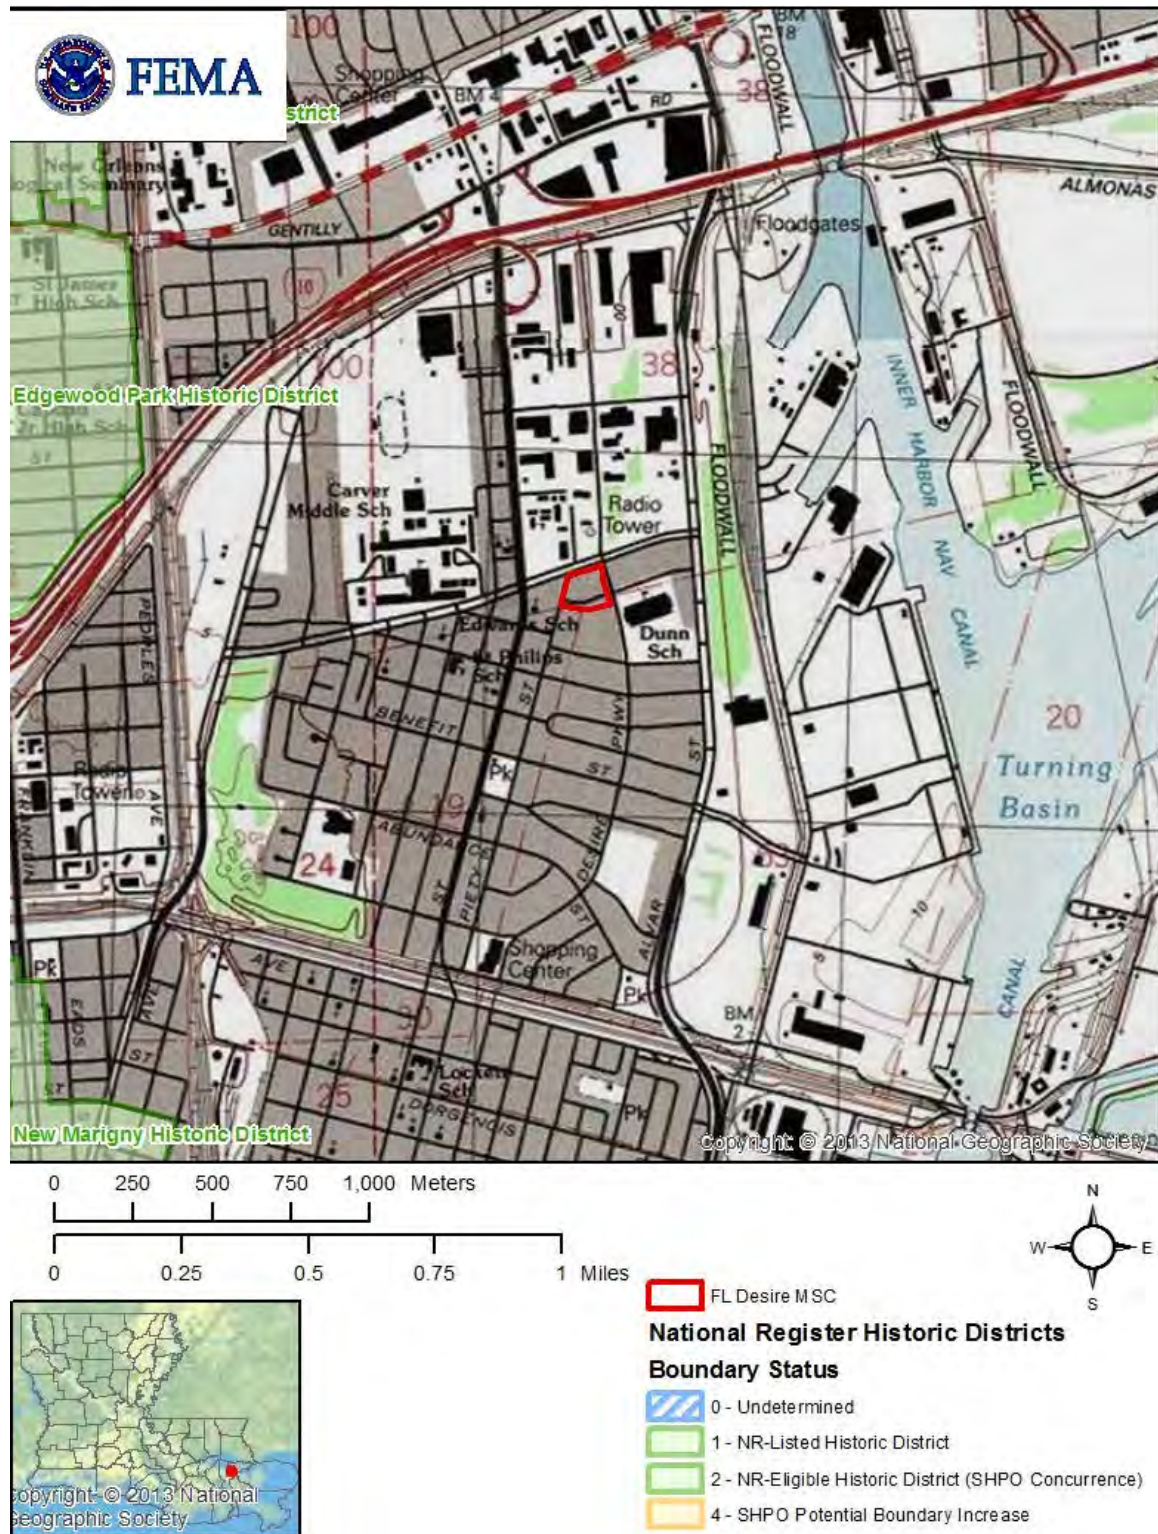


Figure 1. A portion of the Spanish Fort and New Orleans East 7.5' USGS topographic map showing the location of the Desire Florida Community Center Undertaking with near-by Historic Districts.



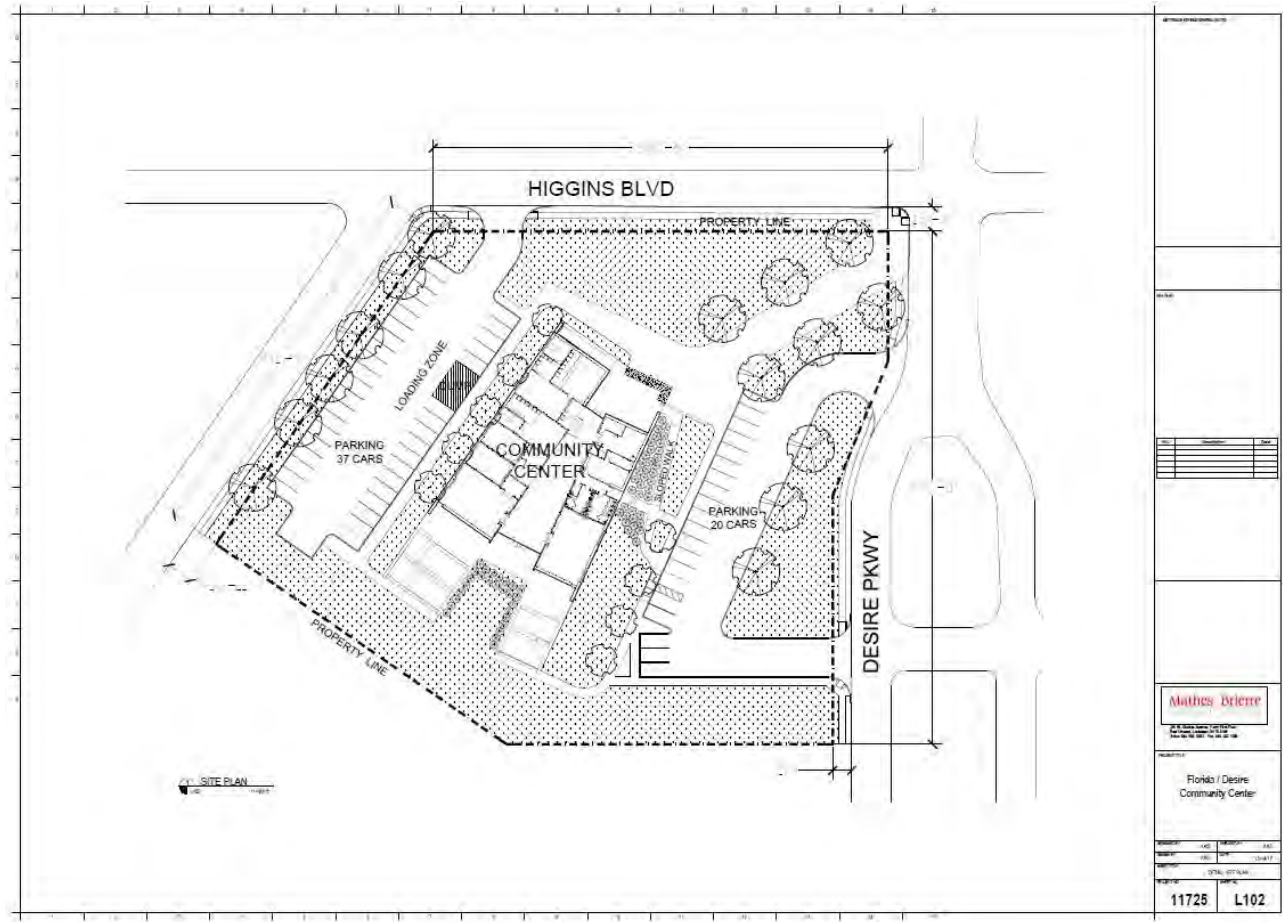


Figure 2. Plan of project area.





Figure 3. Aerial photograph showing the location of the Archaeological and Standing Structures APE (in red).

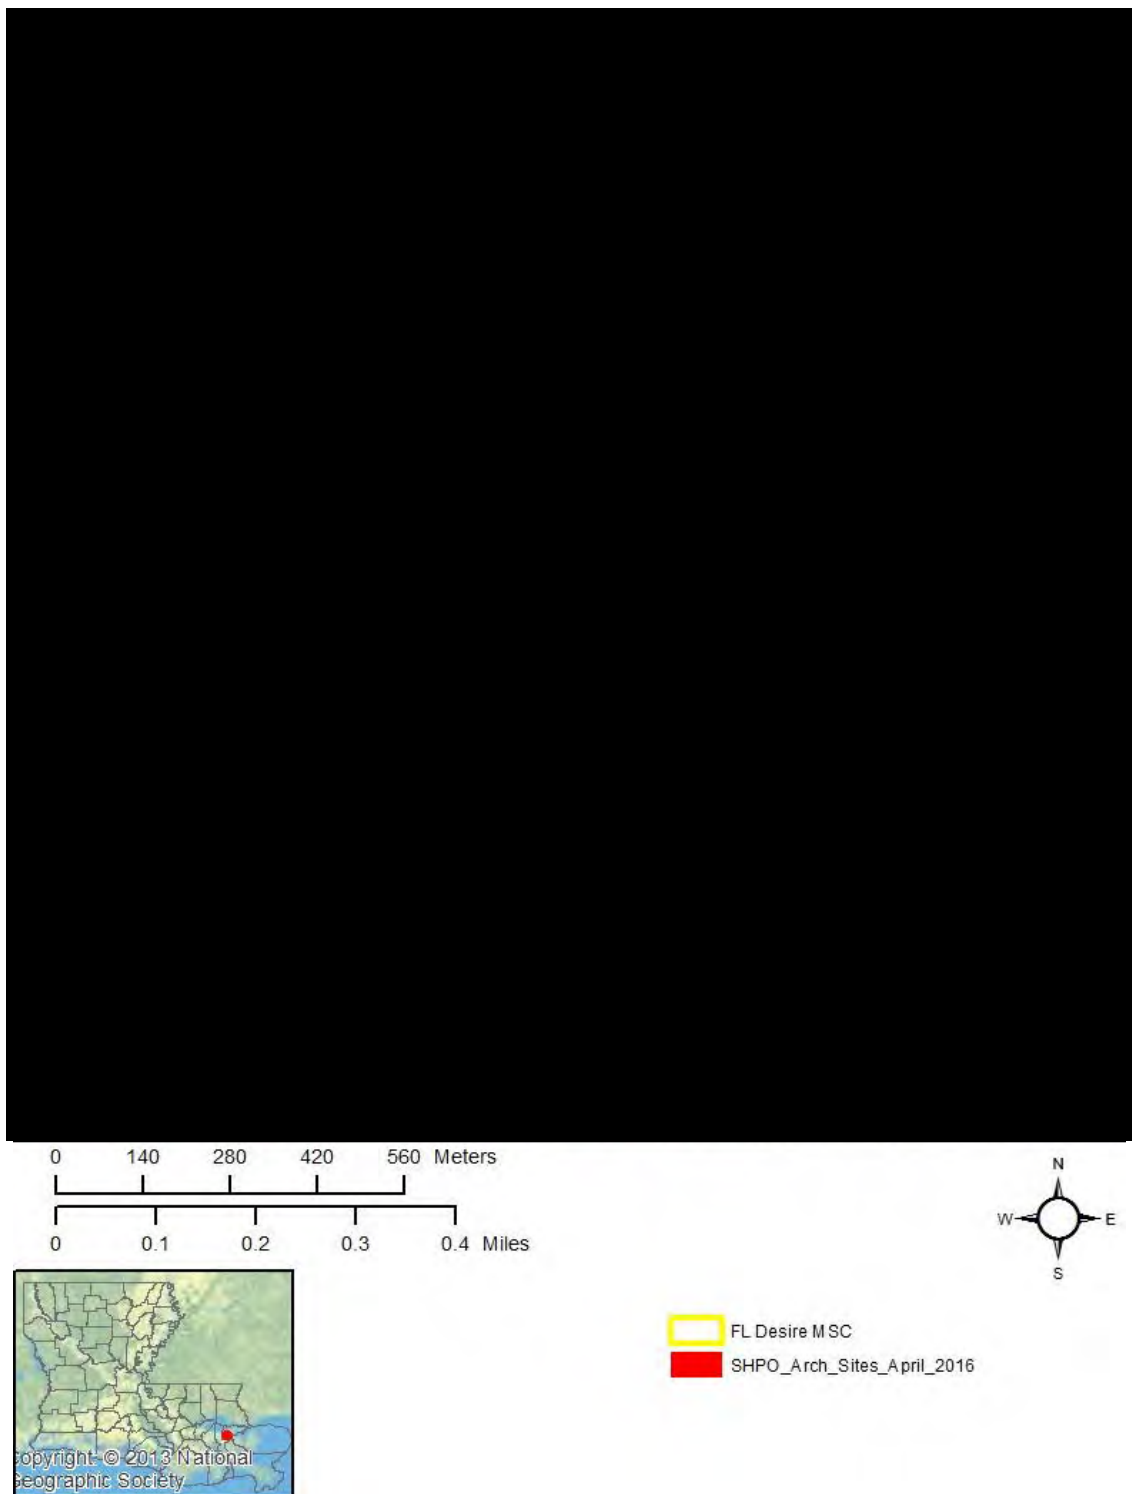


Figure 4. Identified archaeological sites within ½ mile of Archaeological APE. Data provided by Louisiana Division of Archaeology.

**CONFIDENTIAL DO NOT DISCLOSE.** This consultation letter was prepared by the Environmental and Historic Preservation section of the Federal Emergency Management Agency or their contractor. This map is protected from public disclosure in accordance with Section 304 of the National Historic Preservation Act, 16 U.S.C. 470, and 36 CFR 800.11 (c).

## **Appendix E**

### **Public Notice and Draft FONSI**

**PUBLIC NOTICE**  
**FEMA NOTICE OF AVAILABILITY**  
**DRAFT ENVIRONMENTAL ASSESSMENT**  
**DRAFT FINDING OF NO SIGNIFICANT IMPACT**  
**CONSTRUCTION OF A NEW DESIRE FLORIDA MULTI-SERVICE CENTER,**  
**ORLEANS PARISH, LOUISIANA**

Interested parties are hereby notified that the Federal Emergency Management Agency (FEMA) has prepared a Draft Environmental Assessment (DEA) and a draft Finding of No Significant Impact (FONSI) in compliance with the National Environmental Policy Act (NEPA). The purpose of the DEA is to assess the effects on the human and natural environment of the City of New Orleans' (CNO) proposed relocation and construction of a new Desire Florida Multi-Service Center, the proposed action for which FEMA is considering providing funding assistance.

Hurricane Katrina's high winds, heavy rains, and flooding caused considerable damage in the Desire neighborhood of New Orleans. The original Multi-Service Center facility, demolished in 2010, was located at the northeast corner of the intersection of Louisa Street and Florida Avenue, north of the railroad tracks. In accordance with 44 C.F.R. § 206.203(d)(1), the CNO has requested an Improved Project, which would allow funds to restore the pre-disaster function of the damaged community service facility at the newly proposed location. As such, the CNO proposes to relocate and construct a new Desire Florida Multi-Service Center. The new facility would be an approximate 10,000 square foot (sf) multi-service center and would restore the community services capacity in the Desire neighborhood. The new facility would be located on an undeveloped lot owned by the Housing Authority of New Orleans (HANO) which CNO plans to lease the lot prior to construction. The proposed project is located on the southwest corner of the Higgins Boulevard and Desire Parkway intersection in New Orleans, Louisiana 70126. The coordinates of the proposed lot are:

Northwest Corner	Latitude: 29.994273 N	Longitude: -90.033362 W
Northeast Corner	Latitude: 29.994619 N	Longitude: -90.032273 W
Southeast Corner	Latitude: 29.993714 N	Longitude: -90.032092 W
Southwest Corner	Latitude: 29.993632 N	Longitude: -90.033521 W

The purpose of the DEA is to analyze the potential environmental impacts associated with the preferred action and two (2) alternatives. The DEA evaluates a No Action Alternative; the Preferred Action Alternative, which is to construct the Desire Florida Multi-Service Center on the lot bordered by Higgins Boulevard and Desire Parkway, and an Alternative Action, which is to construct the new facility at the Pre-Hurricane Katrina location of the Desire facility at Louisa Street and Florida Avenue.

The draft FONSI is FEMA's finding that the preferred action would not have a significant effect on the human and natural environment.

The draft EA and draft FONSI are available for review at the following locations: New Orleans Public Library - Main Branch, 219 Loyola Avenue, New Orleans, Louisiana, 70112; and the Norman Mayer Public Library, 3001 Gentilly Blvd, New Orleans, Louisiana 70122. Hours of operation are 10:00 a.m. to 8:00 p.m. on Mondays - Thursdays; 10:00 a.m. to 5:00 p.m. on Fridays and Saturdays; and 1:00 p.m. to 5:00 p.m. on Sundays. The documents also can be downloaded from FEMA's website at <http://www.fema.gov/media-library/search>. A public notice for the project will be published for three (3) days - Wednesday, May 9, 2018, Friday; May 11, 2018; and Sunday, May 13, 2018 in the *Times-Picayune*, the journal of record for Orleans Parish; and in The Advocate-New Orleans Edition for three (3) days - Monday, May 7, 2018 through Wednesday, May 9, 2018. In addition, there will be a thirty (30) day comment period, beginning on Monday, May 7, 2018, concluding on Wednesday, June 6, 2018 at 4 p.m. Written comments may be mailed to: DEPARTMENT OF HOMELAND SECURITY-FEMA EHP-DESIRE FLORIDA MULTI SERVICE CENTER, 1500 MAIN STREET, BATON ROUGE, LOUISIANA 70802. Comments also may be e-mailed to [fema-noma@fema.dhs.gov](mailto:fema-noma@fema.dhs.gov) or faxed to (225) 346-5848. Verbal comments will be accepted or recorded at (225) 267-2962. If no substantive comments are received, the draft EA and associated FONSI will become final.



# FEMA

U.S. Department of Homeland Security  
Federal Emergency Management Agency, Region VI  
Louisiana Recovery Office  
1500 Main Street  
Baton Rouge, Louisiana 70802

**FINDING OF NO SIGNIFICANT IMPACT**  
**CONSTRUCTION OF A NEW FLORIDA DESIRE MULTI-SERVICE CENTER**  
**IMPROVED PROJECT, ORLEANS PARISH, LOUISIANA**  
***FEMA-1603-DR-LA***

## **BACKGROUND**

Hurricane Katrina made landfall on 29 August 2005, near the town of Buras, Louisiana, with sustained winds of more than 125 miles per hour. The accompanying storm surge damaged levees and entered the city of New Orleans from various coastal waterways, resulting in flooding throughout much of the city. The storm's high winds, heavy rains, and flooding caused considerable damage throughout New Orleans, Louisiana.

The Applicant has requested, via the State of Louisiana Governor's Office of Homeland Security and Emergency Preparedness (LA GOHSEP), that the Federal Emergency Management Agency (FEMA) provide disaster assistance through federal grant funds pursuant to the Robert T. Stafford Disaster Relief and Emergency Assistance Act (Stafford Act), PL 93-288, as amended. Section 406 of the Stafford Act authorizes FEMA's Public Assistance Program to fund projects to repair, restore, and replace facilities damaged as a result of the declared event. In accordance with 44 C.F.R. § 206.203(d)(1), the City of New Orleans (CNO) has requested an Improved Project, which will allow funds to restore the pre-disaster function of a damaged facility. The CNO proposes construct a new Desire Florida Multi-Purpose Center on an existing undeveloped lot which is owned by the Housing Authority of New Orleans (HANO).

**Pursuant to the Council on Environmental Quality's procedures for implementing the National Environmental Policy Act (NEPA) at 40 C.F.R. § 1506.3 and in accordance with 44 C.F.R. § 10, FEMA regulations to implement NEPA, an Environmental Assessment (EA) was prepared. The alternatives considered consist of: 1) the "No Action" alternative, 2) Construct a new Florida Desire Multi-Service Center at Higgins Boulevard (Preferred Alternative), 3) Construct the new facility at the Pre-Hurricane Katrina location of the Desire facility at Louisa Street and Florida Avenue.**

## **FINDINGS**

FEMA has evaluated the proposed project for significant adverse impacts to geology, soils, water resources (surface water, groundwater, and wetlands), floodplains, coastal resources, air quality, biological resources (vegetation, fish and wildlife, federally-listed threatened or endangered species and critical habitats), cultural resources, socioeconomics (including minority and low income populations), safety, noise, and hazardous materials. The results of these evaluations as well as consultations and input from other federal and state agencies are presented in the EA. During the construction period, short-term impacts to water quality, air quality, and noise are anticipated. All short-term impacts require conditions to minimize and mitigate impacts to the proposed project site and surrounding areas.



## **CONDITIONS**

The following conditions must be met as part of the implementation of the project. Failure to comply with these conditions may jeopardize federal funds:

- The Sub-Recipient must follow all applicable local, state, and federal laws, regulations, and requirements and obtain and comply with all required permits and approvals prior to initiating work.
- If human bone or unmarked grave(s) are present within the project area, compliance with the Louisiana Unmarked Human Burial Sites Preservation Act (R.S. 8:671 et seq.) is required. The Sub-Recipient shall notify the law enforcement agency of the jurisdiction where the remains are located within twenty-four hours of the discovery. The Sub-Recipient shall also notify FEMA and the Louisiana Division of Archaeology at 225-342-8170 within seventy-two hours of the discovery.
- If during the course of work, archaeological artifacts (prehistoric or historic) are discovered, the Sub-Recipient shall stop work in the vicinity of the discovery and take all reasonable measures to avoid or minimize harm to the finds. The Sub-Recipient shall inform their Public Assistance (PA) contacts at FEMA, who will in turn contact FEMA Historic Preservation (HP) staff. The Sub-Recipient will not proceed with work until FEMA HP completes consultation with the SHPO, and others as appropriate.
- Project construction would involve the use of potentially hazardous materials (e.g., petroleum products, including but not limited to gasoline, diesel, brake and hydraulic fluid, cement, caustics, acids, solvents, paint, electronic components, pesticides, herbicides, fertilizers, and/or treated timber) and may result in the generation of small volumes of hazardous wastes. Appropriate measures to prevent, minimize, and control spills of hazardous materials must be taken and generated hazardous or non-hazardous wastes are required to be disposed in accordance with applicable federal, state, and local regulations.
- LDNR requires that a complete CUP Application package (Joint Application Form, location maps, project illustration plats with plan and cross section views, etc.) along with the appropriate application fee, be submitted to their office prior to construction. The Sub-Recipient is responsible for coordinating with and obtaining any required CUPs or other authorizations from the LDNR OCM's Permits and Mitigation Division prior to initiating work. The Sub-Recipient must comply with all conditions of the required permits. All documentation pertaining to these activities and Sub-Recipient compliance with any conditions should be forwarded to the state and FEMA for inclusion in the permanent project files.
- Permittee shall, prior to commencement of the herein permitted activities, contact Billy Wall (phone: 225-342-9423, email: [billy.wall@la.gov](mailto:billy.wall@la.gov)) to determine if a construction permit will be required from the local levee district. This determination does not eliminate the need to obtain a permit from the United States Army, Corps of Engineers or any other Federal, state or local approval that may be required by law. The drawings submitted with your referenced application are attached hereto and made a part of the record. If you have any questions regarding this authorization, please contact our office (225) 342-7591 or (800) 267-4019.
- Sub-Recipient must comply with all local, state, and federal requirements related to sediment control, disposal of solid waste, control and containment of spills, and discharge of surface runoff and/or stormwater from the site.
- The EPA recommends the Sub-Recipient conduct work to determine the extent of wetlands on site. Such investigation should be completed in coordination with the New Orleans District Office of the U.S. Army Corps of Engineers. The EPA also recommends all potential impacts to wetlands and other waters of the United States be avoided and minimized to the maximum extent practicable. Compensatory mitigation will be required for impacts to jurisdictional wetlands, as authorized by a Clean Water Act Section 404 permit, to avoid a net loss of wetlands and wetland functions as a result of the proposed work.

- Care should be taken in equipment and materials storage and construction activities (including equipment and materials staging) to ensure that nearby wetlands are not adversely affected per the CWA and Executive Order 11990.
- If the project results in a discharge to waters of the State, an LPDES permit may be required in accordance with the Clean Water Act and the Louisiana Clean Water Code. If the project results in a discharge of wastewater to an existing wastewater treatment system, that wastewater treatment system may need to modify its LPDES permit before accepting the additional wastewater. In order to minimize indirect impacts (erosion, sedimentation, dust, and other construction-related disturbances) to nearby waters of the U.S. and surrounding drainage areas, the contractor must ensure compliance with all local, state, and federal requirements related to sediment control, disposal of solid waste, control and containment of spills, and discharge of surface runoff and stormwater from the site. All documentation pertaining to these activities and Sub-Recipient compliance with any conditions should be forwarded to LA GOHSEP and FEMA for inclusion in the permanent project files.
- Per 44 C.F.R. § 9.11(d)(6), no project should be built to a floodplain management standard that is less protective than what the community has adopted in local ordinances through their participation in the NFIP. Per 44 C.F.R. § 9.11(d)(9), for the replacement of building contents, materials, and equipment, where possible disaster-proofing of the building and/or elimination of such future losses should occur by relocation of those building contents, materials, and equipment outside or above the base floodplain. The Sub-Recipient is required to coordinate with the local floodplain administrator regarding floodplain permit(s) prior to the start of any activities. All coordination pertaining to these activities and Sub-Recipient compliance with any conditions must be documented and copies forwarded to the LA GOHSEP and FEMA for inclusion in the permanent project files.
- After construction of the proposed project and prior to FEMA project close-out, additional verification will be needed to ensure that proper coordination occurred regarding work within the floodplain. The following documentation will be required:
  - A copy of the Post-Construction Elevation Certificate signed/sealed by licensed surveyor, engineer, or architect *as well as* the local FP administrator; or
  - If the post-construction EC is not signed by the local Floodplain Administrator, then a Certificate of Occupancy signed by the LFA or a letter from the local Floodplain Administrator stating the structure was built in compliance with the local floodplain ordinance.
  - New construction or substantial improvements within special flood hazard areas be protected against flood damage, be anchored in accordance with the building code of the City of New Orleans to prevent flotation, collapse, or lateral movement of the structure, utilize construction materials and utility equipment that is resistant to flood damage, and utilize construction methods and practices to minimize flood damage.
- All activities involving the remediation of known hazardous substances present in on-site soils must be conducted in accordance with LDEQ requirements and as specified in the approved Corrective Action Plan. Activities involving the remediation of as yet undiscovered hazardous substances in on-site soil and groundwater must be conducted in accordance with relevant LDEQ requirements. Remediation activities for such undiscovered contaminants may not begin until LDEQ approval has been received by the Sub-Recipient.
- All waste is to be transported by an entity maintaining a current "waste hauler permit" specifically for the waste being transported, as required by LaDOTD and other regulations.
- Unusable equipment, debris, and material shall be disposed of in an approved manner and location. The Sub-Recipient shall handle, manage, and dispose of petroleum products, hazardous materials, and/or toxic waste in accordance with all local, state, and federal agency requirements. All coordination

pertaining to these activities should be documented and copies forwarded to the state and FEMA as part of the permanent project files.

- Contractor and/or Subcontractors must properly handle, package, transport and dispose of hazardous materials and/or waste in accordance with all local, state, and federal regulations, laws, and ordinances, including all OSHA worker exposure regulations covered within 29 C.F.R. § 1910 and 1926.
- Contractors are required to follow, at a minimum, these BMPs during site work:
  - implement erosion and sediment controls
  - stabilize soils
  - manage dewatering activities
  - implement pollution prevention measures
  - provide and maintain buffers around surface waters
  - prohibit certain discharges, such as motor fuel and concrete washout

## **CONCLUSION**

The results of these evaluations, as well as consultations and input from other federal and state agencies, are presented in the EA. Based on the information analyzed, FEMA has determined that the implementation of the proposed action would not result in significant adverse impacts to the quality of the natural and human environment. In addition, the proposed project does not appear to have the potential for significant cumulative effects when combined with past, present, and reasonably foreseeable future actions. As a result of this FONSI, an Environmental Impact Statement will not be prepared (per 44 C.F.R. § 10.9) and the proposed project as described in the EA may proceed.

## **APPROVALS**

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Tiffany Spann-Winfield,  
Acting Environmental Liaison Officer  
LRO-1603/1607-DR-LA

Date

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Thomas M. (Mike) Womack,  
Director of Louisiana Recovery Office  
FEMA-1603/1607-DR-LA

Date